
LEROY TOWNSHIP PARK PATH PROJECT

INDEX OF SHEETS	
SHEET TITLE	SHEET NUMBER
COVER SHEET	1
GENERAL NOTES	2
SITE PLAN	3
TYPICAL SECTION	4
DETAILS	5

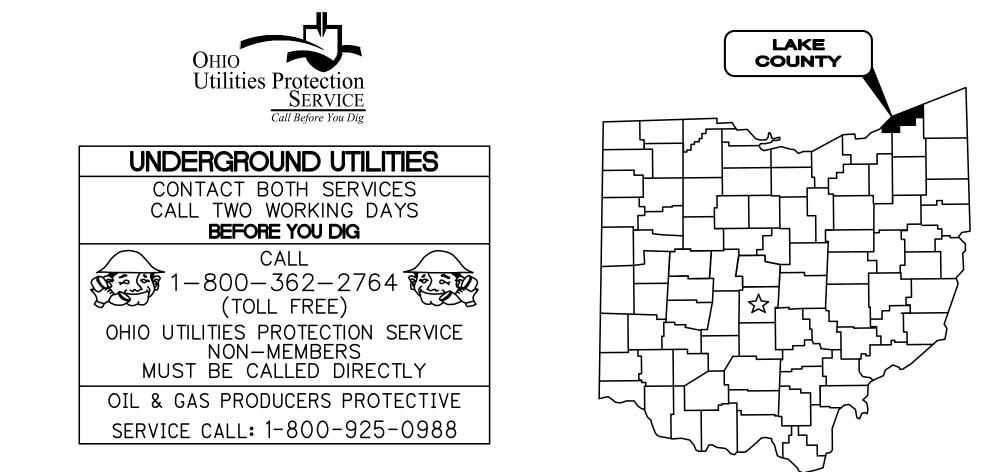

1. THE SURVEY SHOWN ON THESE PLANS WAS OBSERVED IN THE FIELD FOR CONSTRUCTION PURPOSES ONLY AND MAY NOT BE SUITABLE FOR PROPERTY LINE SURVEYS OR ANY OTHER PURPOSE.


 UNDERGROUND BUILDING SERVICE UTILITY LINES ARE NOT SHOWN ON THE PLANS. THE CONTRACTOR SHALL BE RESPONSIBLE FOR LOCATING, MAINTAINING AND REPLACING AS NECESSARY TO ENSURE CONTINUAL SERVICE TO BUILDINGS.

3. THE CONTRACTOR IS RESPONSIBLE TO CALL OHIO UTILITIES PROTECTION SERVICE @ 1-800-362-2764, THREE WORKING DAYS PRIOR TO CONSTRUCTION.

LEROY TOWNSHIP

LAKE COUNTY, OHIO

June, 2024

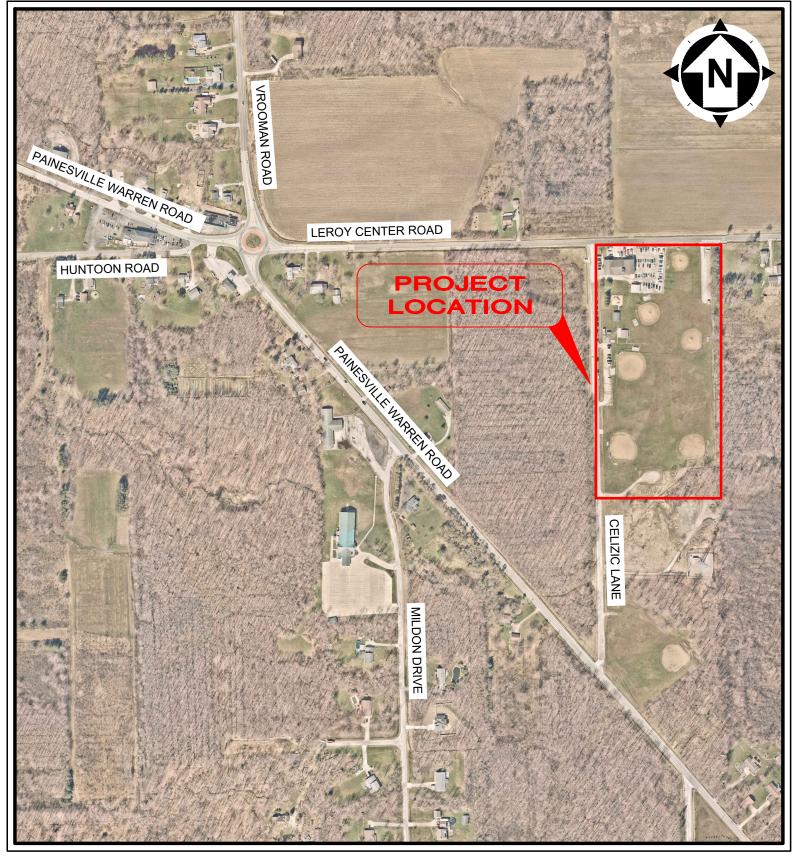

LOCATION MAP SCALE: 1" = 400'



TOWNSHIP TRUSTEES:

RICH VAN PELT . HEATHER SHELTON . JASON RODGERS ..

TOWNSHIP ADMINISTRATORS:

ALEXANDRA C. BROWN
SHARON RODGERS
NOELL SIVERTSEN
MIKE TOMAN
BRANDY HANUSOSKY
RON GRAHAM
JOSEPH RADMORE

PETER J. FORMICA

ENGINEER'S PROJECT No. 241171

•	•	•	•	•	•	•	•	•	•	•	•	•	•	•	•	•	•	•	•	•	•	•	•	•	•	•	•	•	•	• •	•	••	•	•	•	•	C	Դ	łA	١	RI	M	١A	V	-	- ר	R	JS	TE	ΞE
•	•	•	•	•	•	•	•	•	•	•	•	•	•	•	•	•	•	•	•	•	•	•	•	•	•	•	•	•	•	•	•	•	•	••	•	•	•	•	•	•	•	•	••		•	٦	ſRI	JS	TE	ΞE
•	•	•	•	•	•	•	•	•	•	•	•	•	•	•	•	•	•	•	•	•	•	•	•	•	•	•	•	•	•	•	•	•	•	• •	•	• •	•	•	•	•	•	•	••	•	•	٦	R	JS	TE	ΞE

NFISCAL OFFICER
AUXILIARY FISCAL OFFICER
ZONING INSPECTOR
FIRE CHIEF
RECREATION BOARD PRESIDENT
FIRE ADMINISTRATIVE ASSISTANT
ATTORNEY AT LAW



XXX/XXXX DATE

GENERAL NOTES

- THE CONTRACTOR SHALL PERFORM ALL OF THE WORK AND FURNISH ALL OF THE LABOR AND MATERIALS NECESSARY FOR THE FINAL COMPLETION OF THIS CONTRACT IN THE MANNER AND UNDER THE CONDITIONS HEREIN SPECIFIED AND PROVIDED AND IN ACCORDANCE WITH THE CONTRACT DRAWINGS.
- 2. A PRE-CONSTRUCTION MEETING SHALL BE SCHEDULED BY THE ENGINEER PRIOR TO THE COMMENCEMENT OF ANY WORK. IN ADDITION, THE CONTRACTOR SHALL PROVIDE 48 HOUR NOTICE TO LEROY TOWNSHIP PRIOR TO THE COMMENCEMENT OF WORK.
- ACCESS TO THE FACILITY WILL BE MAINTAINED AT ALL TIMES.
- 4. MATERIALS OF WORK FOR "AS DIRECTED" ITEMS SHALL NOT BE ORDERED FOR THE DELIVERY TO THE PROJECT OR WORK PERFORMED UNTIL AUTHORIZED BY THE ENGINEER.
- 5. BEFORE THE TOWNSHIP WILL APPROVE AND ACCEPT THE WORK AND RELEASE THE GUARANTY RETAINER. THE CONTRACTOR SHALL FURNISH THE TOWNSHIP A WRITTEN REPORT INDICATING THE RESOLUTION OF ANY AND ALL PROPERTY DAMAGE CLAIMS FILED WITH THE CONTRACTOR BY ANY PARTY DURING THE CONSTRUCTION PERIOD. THE INFORMATION TO BE SUPPLIED SHALL INCLUDE. BUT NOT BE LIMITED TO. NAME OF CLAIMANT, DATE FILED WITH CONTRACTOR, NAME OF INSURANCE COMPANY AND/OR ADJUSTOR HANDLING CLAIM. HOW CLAIM WAS RESOLVED AND IF CLAIM WAS NOT RESOLVED FOR THE FULL AMOUNT. A STATEMENT INDICATING THE REASON FOR SUCH ACTION.

PATH EXCAVATION AND PAVEMENT

- 1. IT SHALL BE THE RESPONSIBILITY OF THE CONTRACTOR TO NOTIFY THE ENGINEER FORTY-EIGHT (48) HOURS IN ADVANCE OF BEGINNING WORK WHICH REQUIRES PROOF ROLL TESTING AND/OR INSPECTION PRIOR TO PLACEMENT OF PAVEMENT OR BASE. WORK WILL NOT BEGIN UNTIL INSPECTION HAS BEEN COMPLETED AND APPROVED BY THE ENGINEER.
- 2. ALL PAVEMENT / SOIL REMOVAL. NEW PAVEMENT. AND ASSOCIATED ROADWAY WORK WILL BE IN ACCORDANCE WITH THE CURRENT STATE OF OHIO DEPARTMENT OF TRANSPORTATION CONSTRUCTION AND THE MATERIAL SPECIFICATIONS, STANDARD CONSTRUCTION DRAWINGS AND SUPPLEMENTAL SPECIFICATIONS, LATEST ISSUE, WITH THE MODIFICATIONS AS SET FORTH IN THESE SPECIFICATIONS
- 3. THE EXCAVATION, EMBANKMENT AND COMPACTION OF THE NEW ROADWAY SUBGRADES IS PERFORMED IN ACCORDANCE WITH THE REQUIREMENTS OF THE ODOT CONSTRUCTION AND MATERIAL SPECIFICATIONS 203. PROOF ROLLING WILL BE REQUIRED AS DIRECTED BY THE ENGINEER BEFORE PAVING. THE PROOF ROLLING SHALL BE COMPLETED AS FOLLOWS: EXCAVATION OR EMBANKMENT TO FINISHED SUBGRADE. EMBANKMENTS ARE COMPACTED AND TESTED FOR COMPACTION IN 6" LIFTS PER ODOT 203. THE SUBGRADE IS COMPACTED AND TESTED. THE SUBGRADE FOR THE NEW ROAD IS THEN PROOF ROLLED. AREAS EXHIBITING UNACCEPTABLE MOVEMENT UNDER PROOF ROLLING ARE UNDERCUT TO A DEPTH DIRECTED BY THE ENGINEER AND BACKFILLED WITH MATERIALS SPECIFIED IN THE PLANS. THE SUBGRADE IS RE-PROOF ROLLED TO VERIFY THE UTILITY OF THE UNDERCUT. UPON PASSING THE PROOF ROLL THE AREA IS APPROVED FOR THE INSTALLATION OF THE BASE MATERIAL. THE AGGREGATE BASE MATERIAL IS PLACED PER ODOT SPECIFICATIONS. COMPACTED. TESTED AND PROOF ROLLED. UPON PASSING THE PROOF ROLL THE SPECIFIED TOP COURSES OF RIGID PAVEMENT MAY BE INSTALLED MOISTURE CONTENT OF THE SUBGRADE AT THE TIME OF PROOF ROLLING SHALL CONFORM TO SECTION 203.11 OF THE ODOT SPECIFICATIONS. THE MINIMUM EQUIPMENT SHALL CONSIST OF A SINGLE UNIT. TANDEM AXLE DUMP TRUCK CAPABLE OF BEING LOADED TO 30.000 POUND AXLE LOAD. 60,000 POUND GVW. TIRE PRESSURE SHALL BE MAINTAINED AT 90 PSI OR AS SPECIFIED UNDER SECTION 203.14 OF ODOT SPECIFICATIONS. ANY AREA PERMITTING TIRES TO LEAVE A GROOVE OF ONE (1) INCH OR MORE SHALL BE UNACCEPTABLE FOR PAVING. ANY AREA PERMITTING THE TEST VEHICLE TIRES TO LEAVE A GROOVE OF ZERO (0) TO ONE-HALF (1/2) INCH DEEP SHALL BE ACCEPTABLE. ANY AREA PERMITTING THE TEST VEHICLE TIRES TO LEAVE A GROOVE OF ONE-HALF (1/2) INCH TO ONE (1) INCH DEEP SHALL BE AT THE ENGINEER'S DISCRETION.

		NO	REVISION DAT	ATE	LEROY TOWNSHIP	ISSUED FOR:	BID SET	
111111 STATE 04 04 5						ISSUE DATE:	MAY 2024	
¥ PETER J. ¥ ق FORMICA ۲۲	your trusted advisor				LEROY TOWNSHIP PARK	SCALE:	AS SHOWN	
	architects				PATH PROJECT	DESIGNED BY:	PJF	_
	planners					DRAWN BY:	TJM	_
					LAKE COUNTY, OHIO	CHECKED BY:	PJF	

GRASS RESTORATION

- 1. PRIOR TO START OF CONSTRUCTION THE CONTRACTOR SHALL INVENTORY THE SITE FOR EXISTING ORNAMENTAL LANDSCAPE FEATURES INCLUDING LAWN SPRINKLER SYSTEMS AND IRON PINS. ANY LANDSCAPE FEATURE DISTURBED OR DAMAGED BY THE CONTRACTOR'S ACTION SHALL BE RESTORED TO ITS ORIGINAL CONDITION. COST OF INVENTORY AND RESTORATION SHALL BE INCLUDED IN THE UNIT BID PRICE FOR LAWN RESTORATION.
- RESTORATION OF TREELAWNS AND GRASS AREAS IN EASEMENTS SHALL BE PERFORMED BY A LANDSCAPE CONTRACTOR TO BE APPROVED BY THE ENGINEER AND TOWNSHIP. THE LANDSCAPE CONTRACTOR MUST BE EXPERIENCED IN COMMERCIAL INSTALLATIONS AND PROVIDE REFERENCES AND OTHER DETAILED INFORMATION TO ENABLE THE OWNER TO JUDGE HIS EXPERIENCE AND CAPABILITY TO PERFORM THE WORK. GRASS AREAS TO BE RESTORED SHALL BE SEEDED UNLESS OTHERWISE SHOWN ON THE CONTRACT DRAWINGS THE SEED SHALL BE PLACED ON A FOUR (4) INCH BED OF COMPACTED TOPSOIL THAT HAS BEEN RAKED AND BROUGHT TO AN EVEN SURFACE. TOPSOIL SHALL BE SHREDDED AND BE FREE OF ROCKS, ROOTS AND WEEDS. THE CONTRACTOR SHALL PROVIDE TOPSOIL SAMPLES AND SOURCES OF SUPPLY TO THE ENGINEER FOR APPROVAL PRIOR TO DELIVERY OF THE MATERIAL TO THE JOB SITE.

EROSION AND DUST CONTROL

- SEDIMENT CONTROL SHALL BE ACCOMPLISHED BY HYDRO SEEDING AND MULCHING IMMEDIATELY UPON COMPLETION OF EXCAVATION OR FILL AND FINISH GRADING IN ACCORDANCE WITH ODOT ITEM 659 OR AS DIRECTED BY THE ENGINEER.
- 2. THE CONTRACTOR SHALL BEGIN THE RESTORATION PROCESS AS SOON AS CONSTRUCTION IS COMPLETED. PERMANENTLY STABILIZING EACH DISTURBED AREA WITH PERENNIAL VEGETATION INSTALLED ACCORDING TO SOIL CONSERVATION SERVICE STANDARDS AND SPECIFICATIONS.
- 3. THE CONTRACTOR SHALL REMOVE DAILY ALL MUD. SOIL AND DEBRIS THAT MAY BE TRACKED ONTO EXISTING STREETS OR DRIVES BY HIS EQUIPMENT OR THAT OF SUBCONTRACTORS OR SUPPLIERS.
- 4. ALL MATERIALS TO BE DISPOSED OF OFF-SITE MUST BE DISPOSED OF IN AN ENVIRONMENTALLY SOUND MANNER IN ACCORDANCE WITH LOCAL. STATE AND FEDERAL REGULATIONS, NO EXCESS MATERIALS ARE TO BE DISPOSED OF IN ANY WETLAND, FLOOD PLAIN OR OTHER ENVIRONMENTALLY SENSITIVE AREA.
- 5 EROSION CONTROL MEASURES AT THE DISPOSAL SITE MUST BE INSTALLED AND MAINTAINED UNTIL DISPOSAL IS COMPLETE AND THE DISPOSAL SITE IS PERMANENTLY STABILIZED.
- 6. IT SHALL BE THE RESPONSIBILITY OF THE CONTRACTOR TO APPLY WHEN NEEDED OR ORDERED BY THE OWNER WATER OR CALCIUM CHLORIDE PER ODOT 616 FOR THE ALLEVIATION OR PREVENTION OF DUST NUISANCE ORIGINATING FROM HIS CONSTRUCTION ACTIVITIES. SUFFICIENT QUANTITIES OF CALCIUM CHLORIDE SHALL BE STORED ON THE JOB SITE AT ALL TIMES TO BE USED FOR DUST CONTROL. THE COST OF DUST CONTROL SHALL BE INCLUDED IN THE UNIT BID PRICES FOR ALL ITEMS OF THE PROPOSAL.
- 7. OTHER EROSION AND SEDIMENT CONTROL PRACTICES SHALL MINIMIZE SEDIMENT LADEN WATER ENTERING ACTIVE STORM DRAIN SYSTEMS, UNLESS THE STORM DRAIN SYSTEM DRAINS TO A SEDIMENT POND. INLET PROTECTION IS MANDATORY WHERE SEDIMENT SETTLING PONDS WILL NOT BE IMPLEMENTED.

- TOURNAMENT PLAY.

- THE PROJECT LIMITS.

1. ALL STORM SEWERS SHALL BE ASTM F2281 CORRUGATED SMOOTH INTERIOR POLYPROPYLENE (PP) PIPE WITH ASTM 3212 BELL AND SPIGOT JOINTS (WT) UNLESS OTHERWISE SHOWN ON THE PLAN..

EXCESS EXCAVATION

1. ALL EXCESS EXCAVATION SHALL BE DISPOSED OF AT ON SITE LOCATIONS. AS SHOWN ON THE PLAN AND AS DIRECTED BY THE TOWNSHIP.

WORK HOURS

1. CONSTRUCTION ACTIVITIES WILL BE LIMITED TO DAYTIME HOURS 7:00AM TO 5:30 PM. UNLESS APPROVED IN ADVANCE BY THE TOWNSHIP.

2. NO WORK ACTIVITIES SHALL BE PERFORMED BETWEEN JULY13th AND JULY 16th DUE TO

MAINTENANCE OF TRAFFIC / LOCAL ACCESS

1. IT SHALL BE THE RESPONSIBILITY OF THE CONTRACTOR TO MAINTAIN SAFE AND SATISFACTORY LOCAL ACCESS, VEHICULAR AND PEDESTRIAN, TO ALL ABUTTING PROPERTIES WITHIN THE PROJECT. TRAFFIC SHALL BE MAINTAINED IN ACCORDANCE WITH THE OHIO MANUAL OF UNIFORM TRAFFIC CONTROL DEVICES FOR ALL OPERATIONS.

2. THE CONTRACTOR SHALL WORK WITH THE FACILITY PERSONNEL TO PROVIDE TEMPORARY ROUTING FOR PEDESTRIAN AND VEHICULAR TRAFFIC.

3. THE CONTRACTOR SHALL FURNISH. MAINTAIN. AND SUBSEQUENTLY REMOVE ALL NECESSARY SAFEGUARDS SUCH AS BARRICADES, BARRIERS, TEMPORARY PAVEMENT LIGHTING, FLAGMEN, TEMPORARY GUARDRAILS, DETOUR AND CONSTRUCTION SIGNING AND OTHER TRAFFIC CONTROLS SO AS TO AVOID DAMAGE AND/OR INJURY AND INSURE THE SAFETY OF VEHICLES AND PERSONS DURING CONSTRUCTION BOTH WITHIN AND OUTSIDE

SUBSURFACE CONDITIONS AND INFORMATION

1. IT IS THE OBLIGATION AND RESPONSIBILITY OF THE CONTRACTOR TO MAKE THEIR OWN INVESTIGATION OF SUBSURFACE CONDITIONS PRIOR TO SUBMITTING THEIR BID. THE CONTRACTOR MAY EXAMINE RECORDS OF BORINGS AND OTHER SUBSURFACE INVESTIGATIONS, IF AN, UTILIZED FOR DESIGN PURPOSES.


2. BORINGS AND OTHER SUBSURFACE INVESTIGATIONS ARE NOT A PART OF THE CONTRACT DOCUMENTS AND ARE NOT WARRANTED TO SHOW THE ACTUAL SUBSURFACE CONDITIONS. THE CONTRACTOR AGREES THAT THEY WILL MAKE NO CLAIM FOR ADDITIONAL COST AGAINST THE OWNER OR THE ENGINEER. IF. IN PERFORMANCE OF THE WORK THEY FIND THAT THE ACTUAL SUBSURFACE CONDITIONS ENCOUNTERED DO NOT CONFORM TO THOSE INDICATED BY SAID BORINGS AND OTHER SUBSURFACE CONDITIONS.

SEWER INSTALLATION

241	171
DISCI	PLINE
CIV	/IL
SHEET	NAME
GN	N-1
SHEET	OF
2	5

PROJECT NO.

GENERAL NOTES

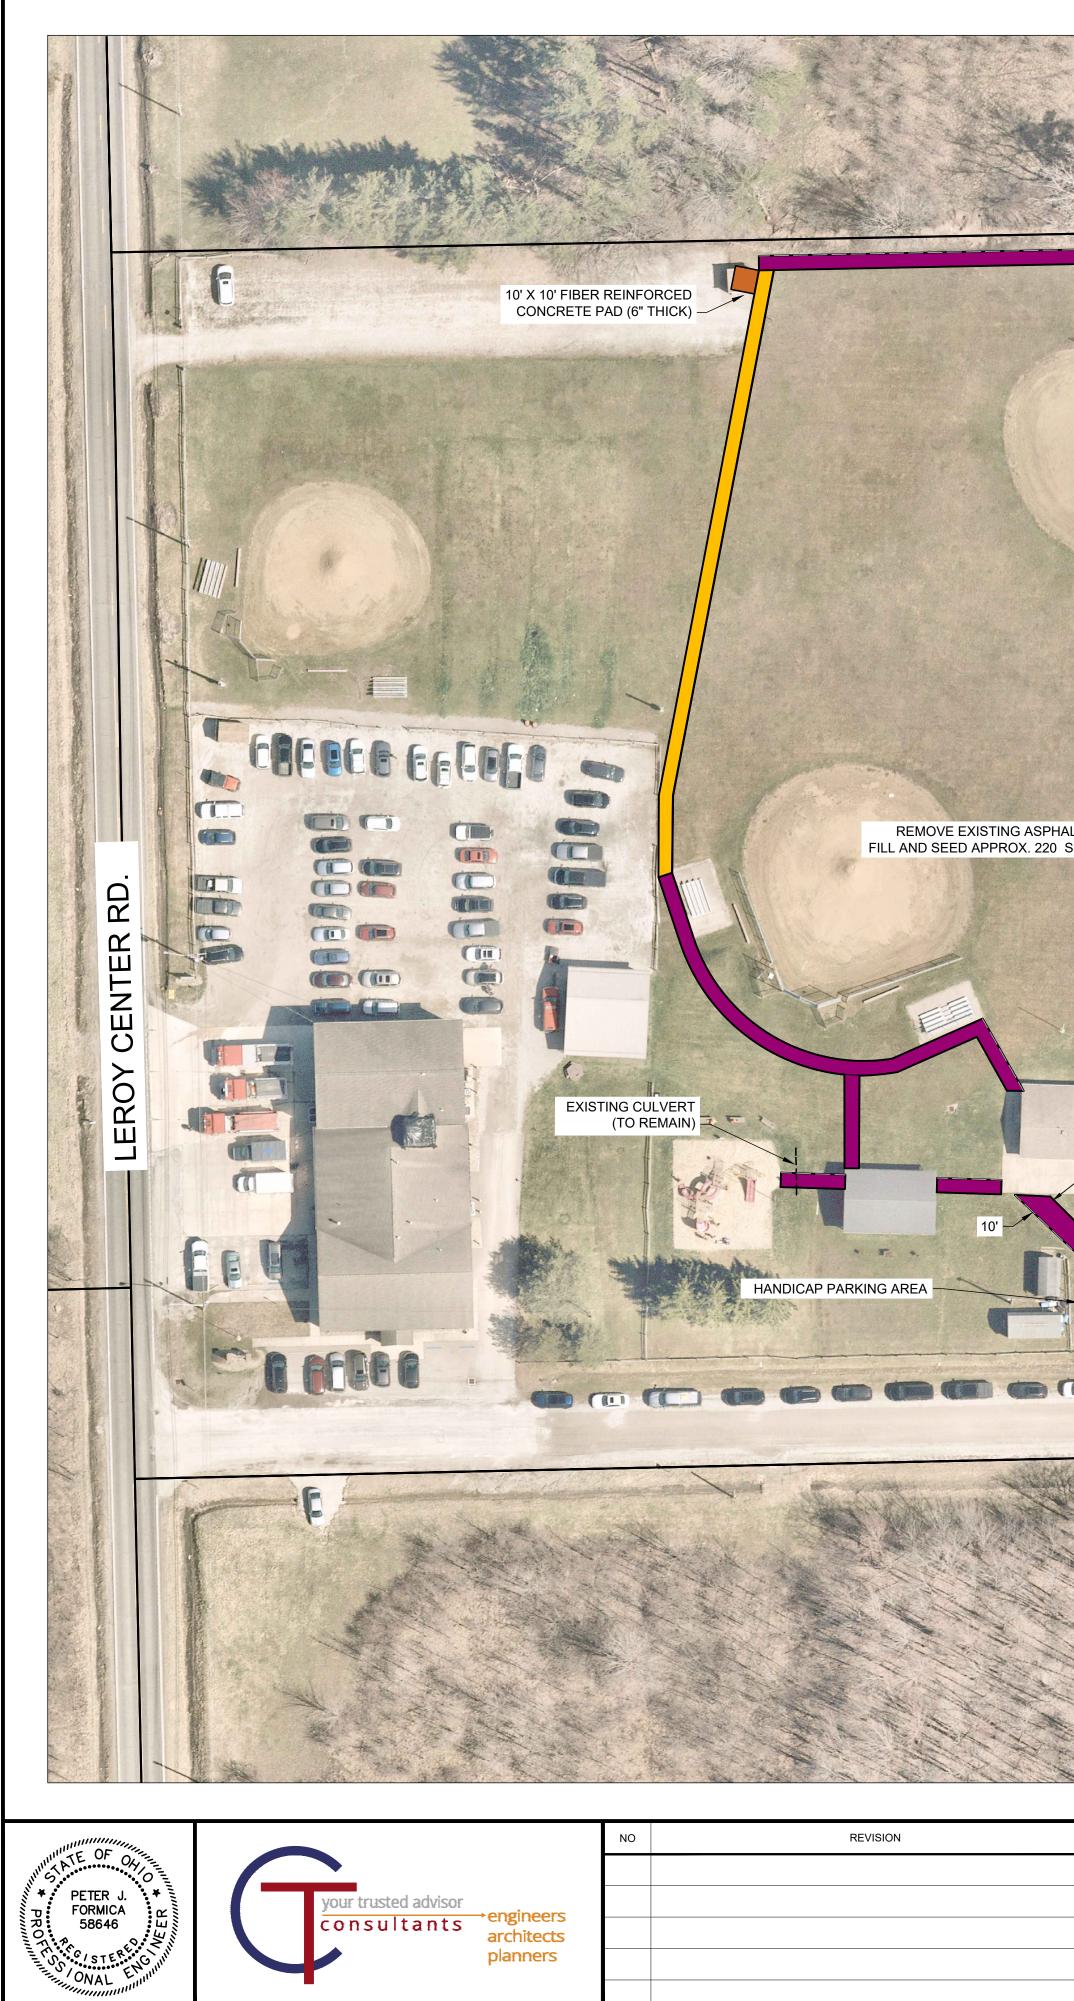

H:\2024\241171\DWG\SHEETS\C_241171 - PLAN.DWG - P-1 - 6/3/2024 1:13:10 PM - BRADY PUGH

		FILL AREA #1- CONTRACTOR TO C	CREATE POSITIVE DRAINAGE	FILL AREA #2
				SHALLOW YARD DRAIN & 8" SHALLOW PIPE UNDERDRAIN TO DAYLIGHT (AS DIRECTED)
ALT, S.F.				INSTALL 40' STORM CULV PIPE, AS DIREC
	KING AREA			EXISTING CO
	CELIZIC LN.			
	LEROY TOWNS EROY TOWNSI PATH PRO	HIP PARK	ISSUED FOR: ISSUE DATE: SCALE: DESIGNED BY:	BID SET MAY 2024 AS SHOWN PJF

LAKE COUNTY, OHIO

DRAWN BY:

CHECKED BY:

ТJМ

PJF

No 2 2 2 2 2 2 2 2 2 2 2 2 2 2 2 2 2 2 2		
	 PROPOSED 6' PA BASE BID (SECTION PROPOSED 6' PA BASE BID (SECTION PROPOSED 6' PA CONTRACT ALTE (SECTION A) PROPOSED OVEF CONTRACT ALTE (SECTION B) NOTE: EXCESS EXCA SHALL BE SPREAD, O AND SEEDED AT LOCATION(S) ON THE PROPERTY AS DIRECT 	ON A) TH - RNATE A RLAY - RNATE B AVATION GRADED, E PARK
SITE PL/	۹N	PROJECT NO. 241171 DISCIPLINE CIVIL SHEET NAME P-1 SHEET OF

SHEET

3

OF

5

LEGEND


① ODOT ITEM 448	1 ¹ / ₂ " ASPHALT CONCRETE SURFACE COURSE,TYPE 1, PG 64-22
2 ODOT ITEM 448	2 ¹ / ₂ " ASPHALT CONCRETE INTERMEDIATE COURSE,TYPE 2, PG 64-22
③ ODOT ITEM 304	6" AGGREGATE BASE
④ ODOT ITEM 204	GEOTEXTILE FABRIC PER ODOT 712.09, TYPE D
(5) ODOT ITEM 204	SUBGRADE COMPACTION
6 ODOT ITEM 203	EXCAVATION
⑦ ODOT ITEM 203	LAWN RESTORATION INCL. LINEAL GRADING AND TOPSOIL, A.P.P.
(8) ODOT ITEM 407	TACK COAT @ 0.05 GAL / S. Y.


NOTES:

2024\241171\DWG\SHEETS\C_241171 - DETAILS.DWG - TS-1 - 5/31/2024 3:11:14 PM - BRADY PUGH

- SLOPE BETWEEN PAVEMENT AND EX. GRADE SHALL BE A MAXIMUM OF 1" PER FOOT
- DEPTH OF EXCAVATION FOR SECTION "A" SHALL BE 9.0" NOMINAL FROM TOP OF EX. GRADE.

		NO	REVISION
111111 ATE 04 04			
FORMICA	your trusted advisor	rs —	
RO 58646	archited	ts	
	planner	S	
STATISTICS ONAL ENDING			

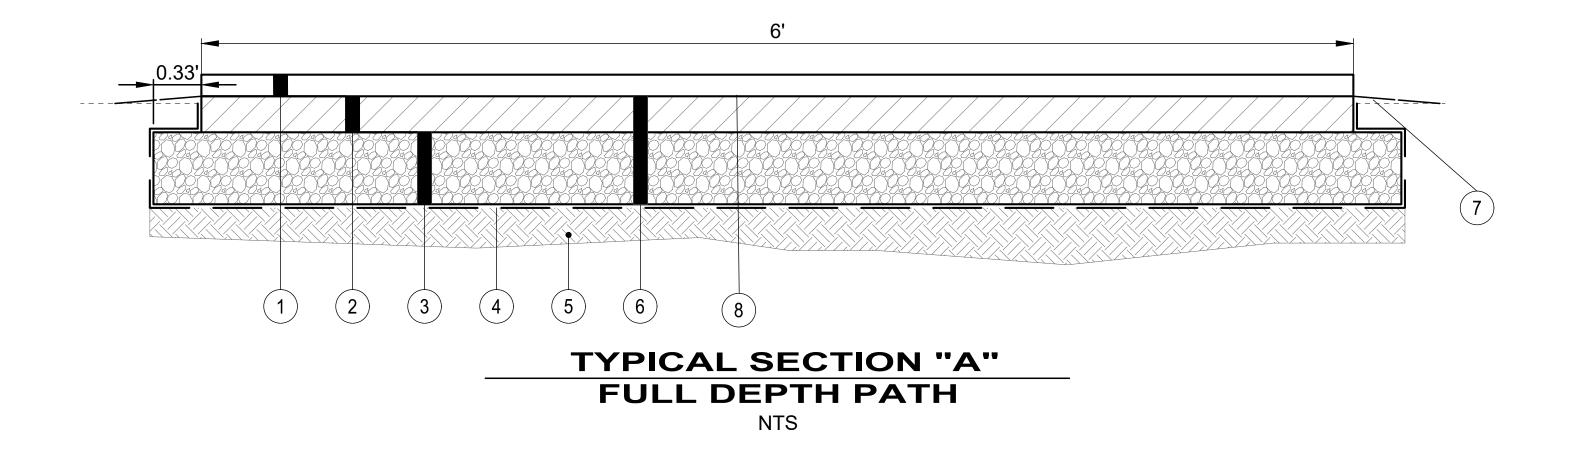


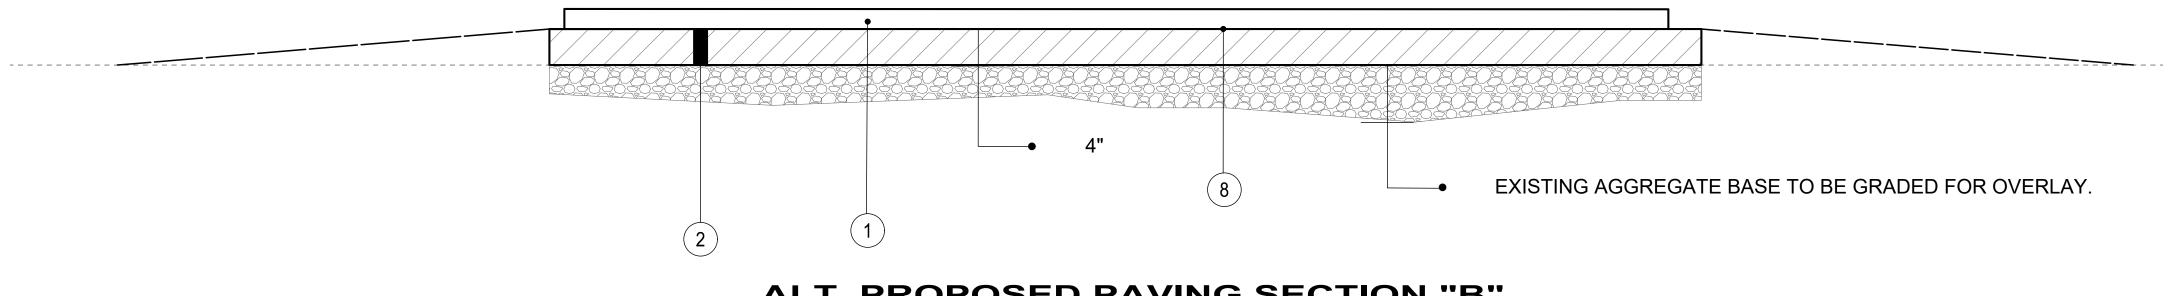

ALT. PROPOSED PAVING SECTION "B" ASPHALT OVER EXISTING PARKING LOT NTS

DATE	LEROY TOWNSHIP	ISSUED FOR:	BID SET	
		ISSUE DATE:	MAY 2024	
	LEROY TOWNSHIP PARK	SCALE:	AS SHOWN	
	PATH PROJECT	DESIGNED BY:	PJF	
		DRAWN BY:	TJM	
	LAKE COUNTY, OHIO	CHECKED BY:	PJF	

	PROJE	CT NO.			
	241171				
	DISCIPLINE				
TYPICAL SECTIONS	CIVIL				
TYPICAL SECTIONS	SHEET NAME				
	TS-1				
	SHEET	OF			
	4	5			

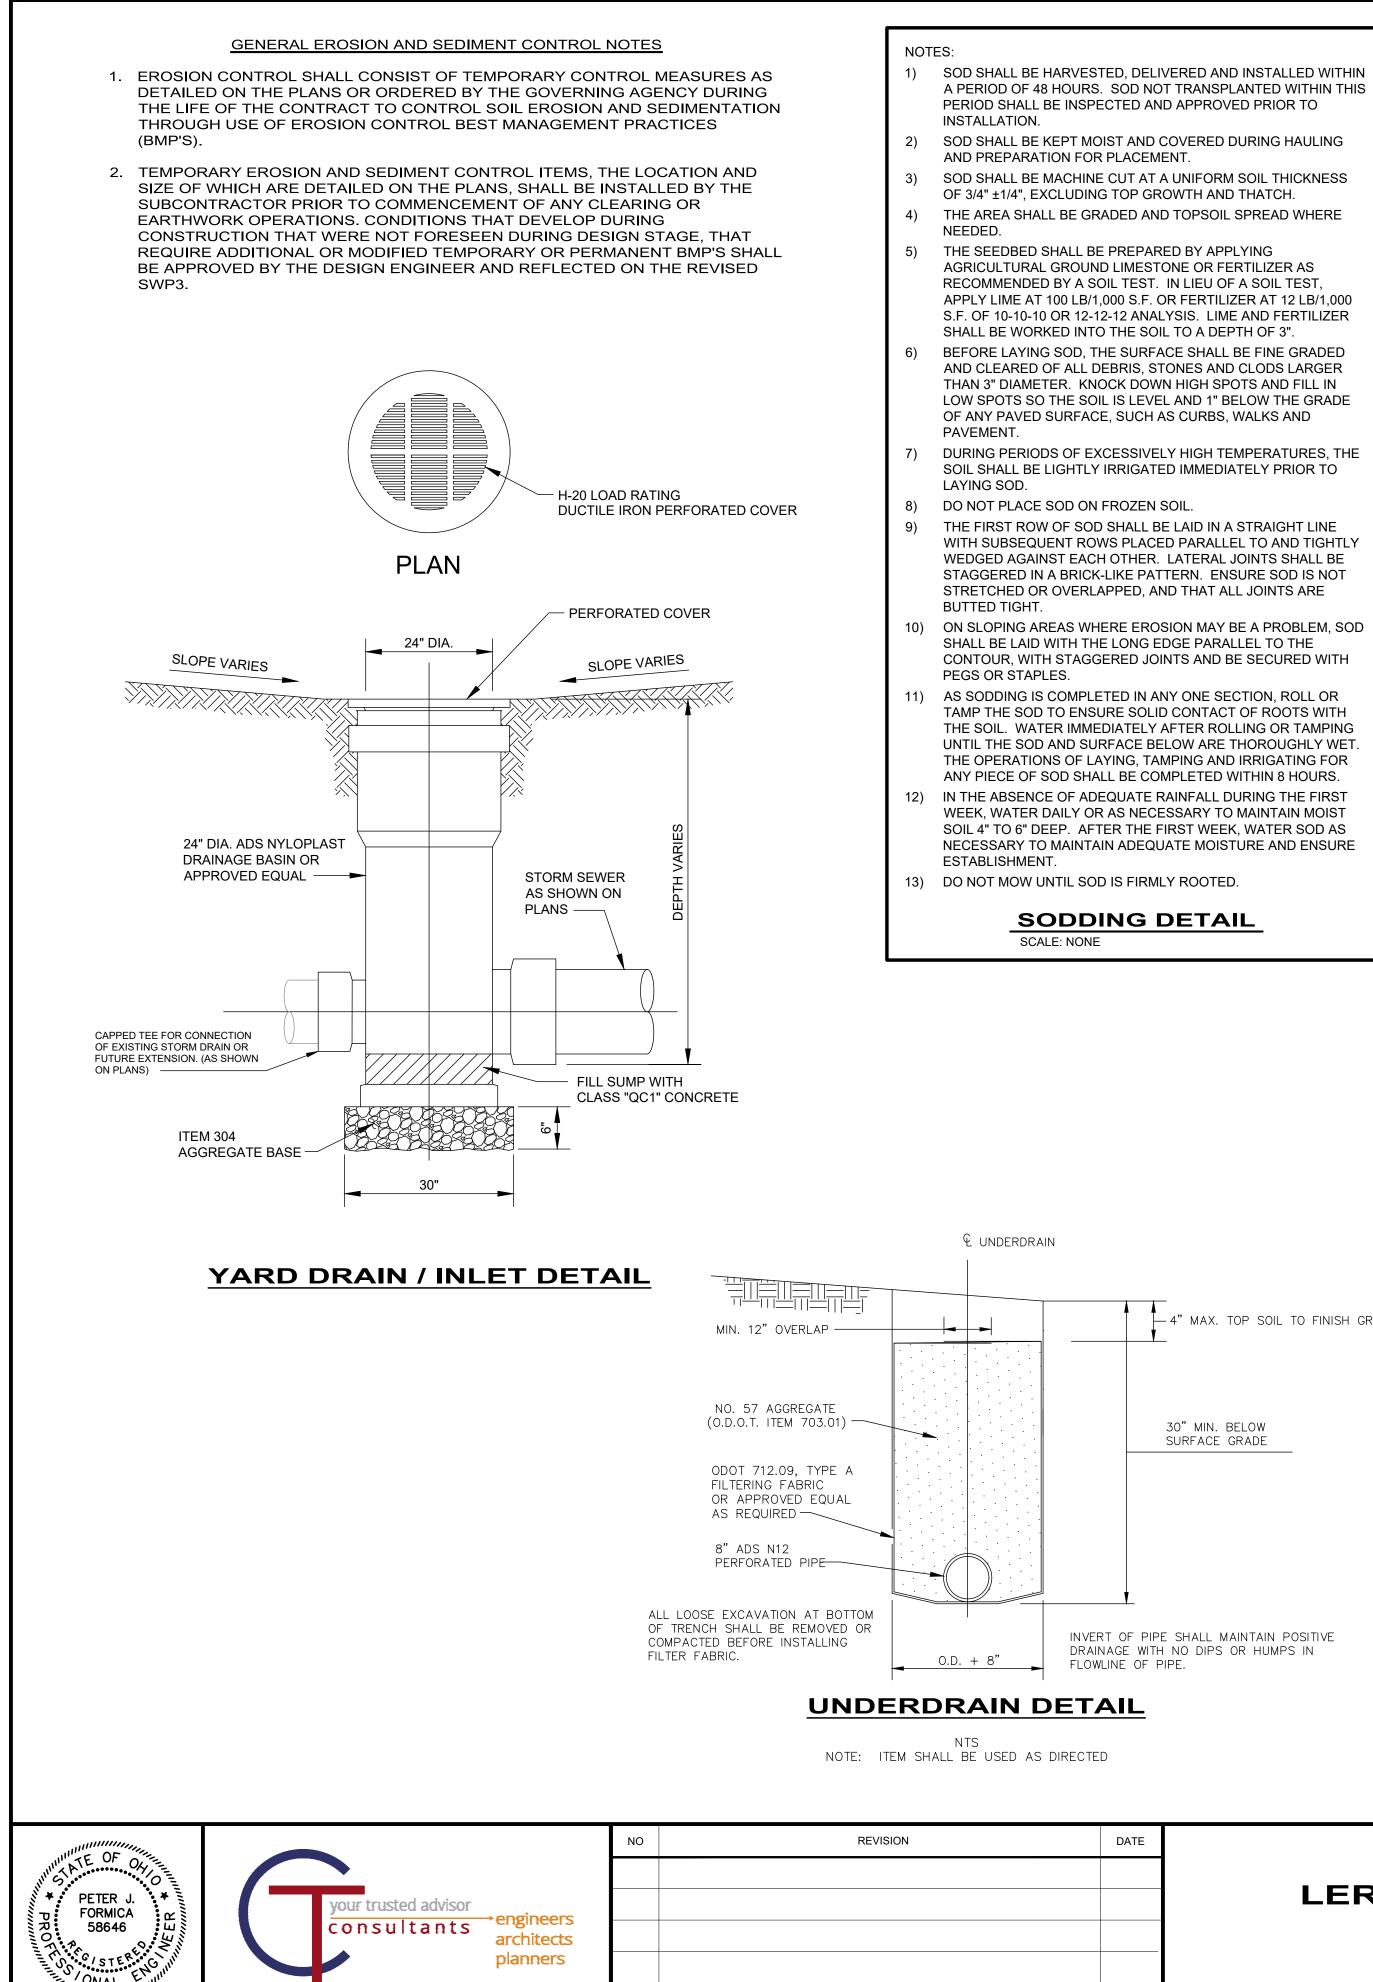

H:2024/241171/DWG\SHEETS\C_241171-EROSION AND SEDIMENT CONTROL.DWG - ESC-1 - 5/31/2024 2:37:16 PM - BRADY PUGH

LA	KE	COL	JNT	(.)	OHIO

LEROY TOWNSHIP PARK PATH PROJECT

LEROY TOWNSHIP

ISSUED FOR:	BID SET	
ISSUE DATE:	MAY 2024	
SCALE:	AS SHOWN	
DESIGNED BY:	PJF	
DRAWN BY:	TJM	

CHECKED BY:

DATE

INVERT OF PIPE SHALL MAINTAIN POSITIVE DRAINAGE WITH NO DIPS OR HUMPS IN FLOWLINE OF PIPE.

30" MIN. BELOW SURFACE GRADE

- 4" MAX. TOP SOIL TO FINISH GRADE

MIXTURE	FORMULA	LB/ AC.	TIME	MOW
CREEPING RED FESCUE DOMESTIC RYEGRASS KENTUCKY BLUEGRASS	10-10-10	500	FALL, YEARLY, OR AS NEEDED	<u>></u> 3"
TALL FESCUE	10-10-10	500		
TURF-TYPE FESCUE	10-10-10	500		<u>></u> 4"
CROWN VETCH FESCUE	0-20-20	400	SPRING, AND	DO
FLAT PEA FESCUE	0-20-20	400	YEARLY AFTER ESTABLISHED	NOT MOW
PERMANENT S	SEEDING SPEC	IES SE	LECTION	
SEED MIX	SEED RATE LB/AC.	NO	TES:	
	GENERAL USE	Ξ		
CREEPING RED FESCUE DOMESTIC RYEGRASS KENTUCKY BLUEGRASS	20 - 40 10 - 20 20 - 40	WA	R CLOSE MOWING TERWAYS WITH ≤ /SEC. VELOCITY	
TALL FESCUE	40 - 50			
TURF-TYPE FESCUE	90			
STEEPI	BANKS OR CUT	SLOP	ES	
TALL FESCUE	40 - 50			
CROWN VETCH TALL FESCUE	10 - 20 20 - 30		NOT SEED LATEF AN AUGUST	R
FLAT PEA TALL FESCUE	20 - 25 20 - 30		NOT SEED LATEF AN AUGUST	R
ROAD	DITCHES AND	SWALE	ES	
TALL FESCUE	40 - 50			
TURF-TYPE FESCUE KENTUCKY BLUEGRASS	90 5			
	LAWN			
KENTUCKY BLUEGRASS PERENNIAL RYEGRASS	100 - 120 100 - 120			
KENTUCKY BLUEGRASS	100 - 120 100 - 120	FO	R SHADED AREAS	

SURVIVE WINTER WE		HONS.		
PERMANENT SEEDING	G FERTILIZATIO	ON AND	MOWING CHART	
MIXTURE	FORMULA	LB/ AC.	TIME	MOW
CREEPING RED FESCUE DOMESTIC RYEGRASS KENTUCKY BLUEGRASS	10-10-10	500	FALL, YEARLY, OR AS NEEDED	<u>></u> 3"
TALL FESCUE	10-10-10	500		
TURF-TYPE FESCUE	10-10-10	500		<u>></u> 4"
CROWN VETCH FESCUE	0-20-20	400	SPRING, AND	DO NOT
FLAT PEA FESCUE	0-20-20	400	YEARLY AFTER ESTABLISHED	MOW

ESTABLISHED FOR AT LEAST 1 FULL YEAR FROM THE TIME OF OR PLANT LOSS AND REPAIR BARE OR SPARSE AREAS, FILL GULLIES, RE-FERTILIZE, RE-SEED OR RE-MULCH AS NEEDED.

- PLANTING. DURING THIS PERIOD, INSPECT FOR SOIL EROSION

- COVER DENSE ENOUGH TO COVER 80% OF THE SOIL SURFACE

- 11) ADEQUATE PERMANENT VEGETATION SHALL BE GROUND BASED ON VISUAL INSPECTION, AND MATURE ENOUGH TO

- SURVIVE WINTER WEATHER CONDITIONS

- FROM RUNOFF.
- IRRIGATION AND MONITOR TO PREVENT EROSION AND DAMAGE 10) PERMANENT SEEDING SHALL NOT BE CONSIDERED
- ADVERSE SITE CONDITIONS AS NEEDED. AVOID EXCESSIVE
- 9) PERMANENT SEEDING SHALL INCLUDE IRRIGATION TO
- APPLY THE SEED MIXTURE, MULCH AND ANCHOR. 8) APPLY MULCH MATERIAL IMMEDIATELY AFTER SEEDING. ESTABLISH VEGETATION DURING DRY OR HOT WEATHER OR ON
- SEEDING RATE BY 50%. PREPARE THE SEED BED. ADD LIME AND FERTILIZER. MULCH AND ANCHOR. CONDITIONS PERMIT, INCREASE THE SEEDING RATE BY

1) SUBSOILING SHALL OCCUR WHEN SOIL MOISTURE IS LOW

ENOUGH TO ALLOW THE SOIL TO CRACK OR FRACTURE.

SUBSOILING IS NOT PERMITTED ON SLIP-PRONE AREAS.

AGRICULTURAL GROUND LIMESTONE OR FERTILIZER AS

RECOMMENDED BY A SOIL TEST. IN LIEU OF A SOIL TEST,

APPLY LIME AT 2 TONS/AC. OR FERTILIZER AT 500 LB/AC. OF

SEEDING SHOULD BE APPLIED FROM MARCH 1 TO MAY 31 OR

REQUIRED TO ENSURE A MINIMUM OF 80% GERMINATION.

THE SOIL IS DRY ENOUGH TO CRUMBLE AND NOT FORM

TILLAGE FOR SEEDBED PREPARATION SHALL OCCUR WHEN

AUGUST 1 TO SEPTEMBER 30. IF SEEDING OCCURS OUTSIDE

OF THESE DATES, ADDITIONAL MULCH AND IRRIGATION MAY BE

10-10-10 OR 12-12-12 ANALYSIS. LIME AND FERTILIZER SHALL BE

2) THE AREA SHALL BE GRADED AND TOPSOIL SPREAD WHERE

THE SEEDBED SHALL BE PREPARED BY APPLYING

WORKED INTO THE SOIL TO A DEPTH OF 3".

RIBBONS WHEN COMPRESSED BY HAND.

4) APPLY SEED UNIFORMLY ON FIRM, MOIST SEED BED.

NOTES:

5)

NEEDED.

- FOR DORMANT SEEDING:

- 50%, PREPARE THE SEED BED, ADD LIME AND FERTILIZER,

- FROM NOVEMBER 20 TO MARCH 15, ONLY IF SOIL
- FROM OCTOBER 1 TO NOVEMBER 20, INCREASE THE
- SEEDING SHOULD NOT BE APPLIED FROM OCTOBER 1 TO NOVEMBER 20 BECAUSE SEEDS MAY GERMINATE, BUT WILL NOT SURVIVE THE WINTER. USE THE FOLLOWING METHODS
- NOTES: 1) FILTER SOCKS SHALL BE 3 OR 5 HDPE 3/8" KNITTED MESH NETTI COMPOST. COMPOST SHALL BE WEED, PAT 2) FREE OF ANY REFUSE, CONTAM TOXIC TO PLANT GROWTH, BE D

LOW

WELL-DECOMPOSED SOURCE C CONSIST OF PARTICLES RANGIN FILTER SOCKS SHALL BE PLACE SLOPES PARALLEL TO THE BASE

2"X2" WOOD

FILTER SOCK -

SEDIMENT

STORAGE AREA -

STAKE -

3" TO 4" -

- 3) **APPROACHING 2:1, ADDITIONAL**
- THE TOP AND MID-SLOPE.
- FILTER SOCKS SHALL BE PLACE 4)
- OF SLOPE FOR SEDIMENT DEPO

- BUILT UP SEDIMENT SHALL BE R 5)
- **REACHED 1/3 THE FILTER SOCK I**
- WHEN A FILTER SOCK IS NO LON
- DISPERSED ON-SITE. 7) THE MAXIMUM DRAINAGE AREA IS 1/2 ACRE AND IS DEPENDENT
- THE GUIDANCE CHART BELOW: MAX. SLOPE LENGTH SLOPE RATIO (H:V) 0 - 50:1 0% - 2%
- 50:1 10:1 2% - 10% 10% - 20% 10:1 - 5:1 20% - 50% 5:1 - 2:1 > 50% <u>></u> 2:1
- FILTER SOC SCALE: NONE
- 1) THE SEED BED SHALL BE PULVER THE SUCCESS OF ESTABLISHING 2) SOIL AMENDMENTS MAY BE REQU VEGETATION. PERFORM SOIL TE THE NEED FOR LIME AND FERTILIZ 3) APPLY SEED UNIFORMLY. COVER RAKING OR DRAGGING AND THEN 4) APPLY MULCHING IMMEDIATELY A 5) SEEDING SHALL BE INSPECTED F WASHOUTS, AND RESEEDED AS N TEMPORARY SEEDING S SPECIES DATES MARCH OATS TALL FESCUE то AUGUST 15 PERENNIAL RYEGR PERENNIAL RYEGR TALL FESCUE AUGUST 16 RYE то TALL FESCUE NOVEMBER 1 PERENNIAL RYEGR WHEAT TALL FESCUE PERENNIAL RYEGR PERENNIAL RYEGR TALL FESCUE

NOTES:

- NOVEMBER 1 ONLY MULCH OR D
- TO SPRING TEMPORARY SE SCALE: NONE
- - Ε

PJF

PERMANENT SEEDING DETAIL SCALE: NONE

		12" MIN	,	5' FLAT SLOPE IN FRONT OF BARRIER	1	>77.
NG MATE	itinuous, ⁻ Erial, fille	ED WITH	H		FLOW	
IINANTS (DERIVED DF ORGAI	AND INSEC OR OTHER FROM A NIC MATTEI I 3/8" TO 2".	MATER R, AND	RÍALS	SECTION		
E OF THE	EVEL LINE SLOPE. O SHALL BE P	N SLOF	PES	WRAP GEOTEXTILE		
osit. Removee Height. Nger Re	AST 5' FROM D WHEN IT H QUIRED, IT FEET OF F	HAS ⁻ SHALL	- BE	AROUND STAKES BEFORE DRIVING	BACKFILL TRE AND COMPA	
	SLOPE FOL					
	FILTER SOC			JOINING SECTIONS OF SILT FENCE		
) 8"		18" 300'	24" 350'	FABRIC PROPERTIES VALUES	TEST MET	НОР
125		200'	250'	GRAB TENSILE 90 LB. MIN	ASTM	
75'		150'	200'	STRENGTH MULLEN BURST 190 PSI MIN	D-1682 ASTM	
N/A	50'	75'	100'	STRENGTH	D-3786	
N/A	25'	50'	75'	SLURRY FLOW RATE 0.3 GAL./MIN./S.F. MAX		
<u>CK D</u>	ΕΤΑΙ	<u>L_</u>		EQUIVALENT OPENING 40-80 SIZE	US STD. S CW-022	15
				ULTRAVIOLET 90% MIN RADIATION STABILITY	ASTM-G	-26
I LIGHTL' AFTER SI OR BARE NECESSA	E SPOTS AN	INTO P		 OTHER WAY BECOMES A CONCENTRATED F THE LAYOUT OF THE SILT FENCE, REMOVE A SEDIMENT OR INSTALL OTHER PRACTICES. 4) SILT FENCE SHALL BE INSPECTED FOR DEPT TEARS, VERIFICATION FABRIC IS SECURELY FENCE POSTS, AND VERIFICATION FENCE PO THE GROUND. BUILT UP SEDIMENT SHALL B SILT FENCE WHEN IT HAS REACHED 1/3 THE 	ACCUMULATED TH OF SEDIMENT ATTACHED TO DSTS ARE FIRML E REMOVED FRO	, Y IN
	LB/1,000 SF		B/AC. 128	SILT FENCE SCALE: NONE		
ASS	1 1		40 40			
ASS	2 1		40 40			
ASS	3 1 1		112 40 40			
	3 1		120 40			
ASS ASS	1		40 40			
	1 SEEDING.		40			
EDIN	IG DE	ΤΑ				
					PROJE	
		~ • •			DISCI	PLINE
ROSION AND SEDIMENT CONTROL & DETAILS					CIN	
					ES	C-1
					SHEET 5	of 5

10 FT MAX. SPACING

LEVEL CONTOUR NO SLOPE

ELEVATION

– EX. GROUND