
# CITY OF FORT THOMAS CAMPBELL COUNTY, KENTUCKY FORT THOMAS 2024 STREET RESURFACING PROGRAM

240102

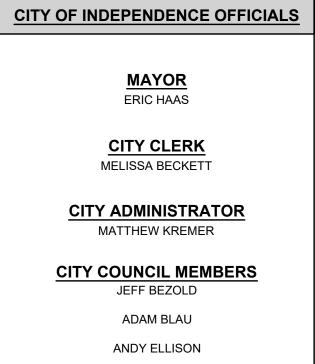

ANDY ELLISON


LAUREN MCINTOSH

BEN PENDERY

ERIC STRANGE

GENERAL SERVICES DIRECTOR
KEVIN BARBIAN

PUBLIC WORKS DIRECTOR
TIM MATTINGLY

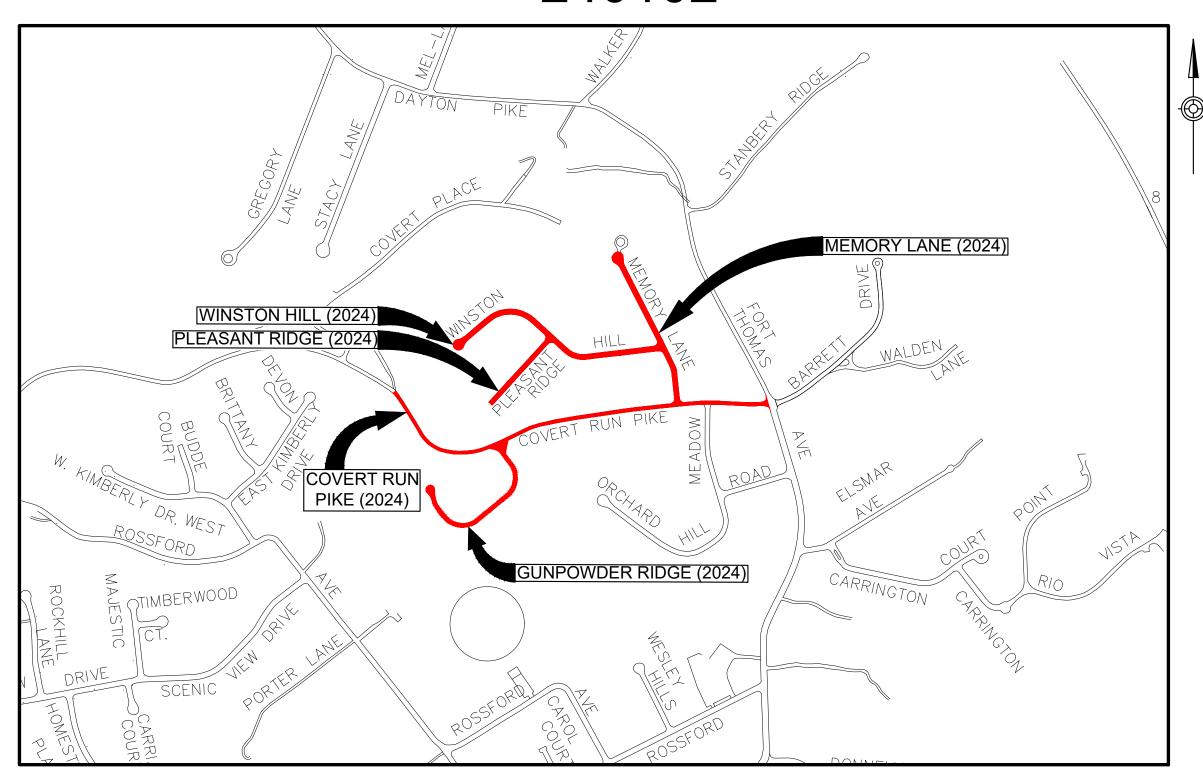

**VICINITY MAP** 

# K.T.C SPECIFICATIONS

THE LATEST STANDARD SPECIFICATIONS OF THE KENTUCKY TRANSPORTATION CABINET, INCLUDING CHANGES AND SUPPLEMENTAL SPECIFICATIONS THERETO.

# SOURCE OF BOUNDARY INFORMATION

THE BOUNDARY INFORMATION SHOWN ON THESE PLANS IS BASED UPON CAMPBELL COUNTY G.I.S. MAPPING AND DOES NOT REPRESENT AN ACTUAL FIELD BOUNDARY SURVEY BY CT CONSULTANTS, INC.




INDEX OF SHEETS		
NO.	DWG NAME	SHEET NAME
1	TTL	TITLE SHEET
2	NOTES	NOTES & LEGEND
3	DTL	DETAIL SHEET
4	PLN 1	WINSTON HILL ROAD BEGIN WORK TO 13+83
5	PLN 2	WINSTON HILL ROAD STA. 13+83 TO STA. 17+68
6	PLN 3	WINSTON HILL ROAD STA. 17+68 TO END WORK
7	PLN 4	PLEASANT RIDGE AVE. BEGIN WORK TO END WORK
8	PLN 5	MEMORY LANE BEGIN WORK TO END WORK
9	PLN 6	COVERT RUN PIKE BEGIN WORK TO STA. 43+75
10	PLN 7	COVERT RUN PIKE STA. 43+75 TO STA. 52+14
11	PLN 8	COVERT RUN PIKE STA. 52+14 TO END WORK
12	PLN 9	GUNPOWDER RIDGE BEGIN WORK TO END WORK
13	ALT A	ALTERNATE BID A FORT THOMAS CITY BUILDING LOT
14	ALT B	ALTERNATE BID B MITCHELL HILL RESURFACING
15	ALT C	ALTERNATE BID C TOWER PARK THEATER PATH

ON					
BID	04/11/2024	1" = 40'	HCUN	HCUN	RSEI
ISSUED FOR:	ISSUE DATE:	SCALE:	DESIGNED BY:	DRAWN BY:	СНЕСКЕВ ВҮ:
48	RESURFACING	CAMPRELL COUNTY KENTLICKY		TITLE SHEET	
		PROJE 240		2	
		DISCI			
		SHEET	NAME		
:	SHEET	<b>T</b>	ΓL	OF	
	1			15	

ROBERT K. SEITZINGER

P.E. #33805

GENERAL NOTES	<u>UTILITY NOTES</u>	MAINTENANCE OF TRAFFIC NOTES		SYMBOL LEGEND	
ALL CONSTRUCTION SHALL CONFORM TO THESE PLANS AND SPECIFICATIONS, THE LATEST EDITION OF THE CITY OF FORT THOMAS SUBDIVISION REGULATIONS AND THE KENTUCKY DEPARTMENT OF HIGHWAYS STANDARD SPECIFICATIONS FOR ROAD AND BRIDGE CONSTRUCTION.	THIS PLAN SHOWS THE APPROXIMATE LOCATION OF UNDERGROUND UTILITIES (GAS, WATER, STORM SEWER, SANITARY SEWER, TELEPHONE, ELECTRIC, ETC.). THE PREPARER DOES NOT GUARANTEE THEIR ACCURACY OR CORRECTNESS. THE INFORMATION PROVIDED SHALL BE	ALL MAINTENANCE OF TRAFFIC PROCEDURES SHALL MEET THE REQUIREMENT     OF THE MANUAL OF UNIFORM TRAFFIC CONTROL DEVICES AND SECTION 112 OF     KTC STANDARD SPECIFICATIONS. THE CONTRACTOR SHALL MAINTAIN ACCESS		——————————————————————————————————————	
EXPANSION MATERIAL SHALL BE FLEXIBLE FOAM MATERIAL, SUCH AS CERAMAR BY W.R. MEADOWS OR APPROVED EQUAL, INSTALLED IN AREAS OF	FIELD VERIFIED PRIOR TO CONSTRUCTION. THE CONTRACTOR SHALL BE RESPONSIBLE FOR MAINTAINING THE UTILITY AS WELL AS THE SERVICE LATERALS AT ALL TIMES DURING CONSTRUCTION. THE CONTRACTOR	TO LOCAL TRAFFIC (ACCESS TO RESIDENCES WITHIN CONSTRUCTION LIMITS) AT ALL TIMES. THE CONTRACTOR SHALL PROVIDE SUFFICIENT SIGN, WARNING LIGHTS, BARRICADES, OR OTHER NECESSARY DEVICES MAKE THE SITE SAFE TO		——————————————————————————————————————	
CONCRETE WALK, DRIVES OR CURB/GUTTER ONLY AT THE FOLLOWING:  A. AT ALL FIXED OBJECTS (I.E. UTILITY COVERS, VALVES, MANHOLES, ETC.)	SHALL PRACTICE CARE DURING THE GRADING AND TRENCH EXCAVATION AND SHALL BE RESPONSIBLE FOR REPLACING ANY SERVICES THAT ARE DAMAGED DURING CONSTRUCTION AT THEIR	THE TRAVELING PUBLIC.  2. IT SHALL BE THE CONTRACTOR'S RESPONSIBILITY TO SUBMIT TO THE ENGINEER		——————————————————————————————————————	
B. AT ALL RIGID STRUCTURES (I.E. DRIVES, CURBS, STEPS, ETC.) PAYMENT FOR THIS ITEM AND ZIP STRIPS INCLUDED IN THE PERTINENT CONCRETE	EXPENSE.  2. PRIOR TO ANY EXCAVATION OVER AN EXISTING UTILITY LINE OR	AND THE OWNER A TRAFFIC CONTROL PLAN FOR THIS PROJECT.  3. PRIOR TO ANY CONSTRUCTION, THE CONTRACTOR SHALL NOTIFY THE CITY OF		======================================	ភ <b>វ</b>
PAVEMENT UNIT PRICE.  C. AT ALL STREET INTERSECTIONS AT THE POINT OF CURVATURE OF THE	SERVICE, CONTRACTOR SHALL HAND EXCAVATE TO EXPOSE THE UTILITY AND DETERMINE LOCATION AND DEPTH. NOTIFY ENGINEER IMMEDIATELY OF ANY CONFLICTS.	FORT THOMAS, AS WELL AS THEIR POLICE AND FIRE POLICE DEPARTMENTS. AT ALL TIMES, EMERGENCY VEHICLES SHALL BE GIVEN ACCESS.			gineers chitects
TURNING RADII ENTERING THE INTERSECTION.  D. NO CONCRETE SHALL BE LEFT ABOVE THE EXPANSION MATERIAL OR	3. TOPS OF EXISTING AND PROPOSED CASTING ELEVATIONS ARE SUBJECT TO FINAL ADJUSTMENTS AS APPROVED BY THE ENGINEER AND	4. RESIDENTS OF THE PROJECT AREA SHALL BE ALLOWED ACCESS TO THEIR PROPERTY AT ALL TIMES.  5. SUPPLY THE PROJECT AREA SHALL BE ALLOWED ACCESS TO THEIR PROPERTY AT ALL TIMES.		——————————————————————————————————————	<b>a a b a c c c c c c c c c c</b>
ACROSS THE JOINT AT ANY POINT. ANY CONCRETE SPANNING THE ENDS OF THE JOINT NEXT TO THE FORMS SHALL BE CAREFULLY CUT AWAY AFTER THE FORMS ARE REMOVED. BEFORE THE PAVEMENT IS OPENED TO	REQUIREMENTS OF UTILITY OWNER. THIS WORK WILL BE INCIDENTAL TO THE CONTRACT.	5. EACH DRIVEWAY SHALL BE ACCESSIBLE WHENEVER POSSIBLE. WHEN PORTLAND CEMENT CONCRETE CONSTRUCTION AFFECTS A DRIVEWAY, THE CONTRACTOR SHALL NOTIFY THE AFFECTED OWNERS 24 HOURS IN ADVANCE		650650	advisor ants
TRAFFIC, THE GROOVE ABOVE THE EXPANSION JOINT MATERIAL SHALL BE CLEANED AND SEALED WITH JOINT SEALING MATERIAL.  ROADWAY REPLACEMENT PROJECT MAY NOT BEGIN BEFORE AUGUST 01, 2024	4. FORTY-EIGHT (48) HOURS BEFORE EXCAVATION IS TO COMMENCE, THE CONTRACTOR SHALL NOTIFY THE FOLLOWING AGENCIES: THE KENTUCKY UTILITY PROTECTION SERVICE AND ALL OTHER UTILITIES THAT MAY HAVE UNDERGROUND UTILITIES INVOLVING THIS PROJECT	AND ADVISE THEM TO FIND ALTERNATIVE PARKING FOR A PERIOD OF AT LEAST 10 CALENDAR DAYS AFTER THE POUR. ALTERNATIVE PARKING SHALL INCLUDE "ON STREET" PARKING WITH ACCESS TO THE PROPERTY. TEMPORARY SIDEWALKS, ETC. WILL BE NECESSARY TO PREVENT PERSONS FROM WALKING		——————————————————————————————————————	usted a
AND SHALL BE SUBSTANTIALLY COMPLETE NO LATER THAN OCTOBER 30, 2024.	AND ARE NON-MEMBERS OF KENTUCKY UNDERGROUND PROTECTION.	IN MUD IN ORDER TO ENTER THEIR PROPERTY. TEMPORARY BRIDGES, RAILINGS ETC. WILL BECOME NECESSARY IN ORDER TO CROSS FORMED CURB LINES, EXCAVATED AREAS BEHIND CURB LINES AND WALKWAYS, ETC.		EXISTING GUARDRAIL EXISTING TREE LINE	your tra
DOWNSPOUT AND UNDERDRAIN CONSTRUCTION SHALL MEET THESE AND THE LATEST SPECIFICATION OF THE CITY OF FORT THOMAS SUBDIVISION REGULATIONS, SD-1 REGULATIONS AND STANDARD DRAWINGS, AND DETAILS				———— GAS————————————————————————————————	
SHOWN ON THIS PLAN. BEDDING, BACKFILLING, JOINTS, EXCAVATION AND INSTALLATION SHALL BE INCLUDED IN THE COST PER FOOT OF PIPE. STORM SEWER, DOWNSPOUT AND UNDERDRAIN PIPE MATERIAL SHALL HAVE A				GS GS GS GS GS PROPOSED GAS SERVICE  ELEC-UG FLEC-OH EXISTING ELECTRIC (UNDERGROUND / OVERHEAD)	
MANNING'S "N" VALUE OF 0.013 OR LESS (UNLESS OTHERWISE SHOWN) AND BE RIGID / SMOOTH INTERIOR WALLED PVC SDR-35 PIPE, RIBBED PVC PIPE, A-2000 PVC PIPE, UNLESS OTHERWISE SHOWN.				CATV-UG ————————————————————————————————————	
ALL DISTURBED AREAS ARE TO BE RESTORED (SEEDED AND MULCHED) BY THE CONTRACTOR AND SHALL PROCEED WITH JOB PROGRESSION. THE				PROPOSED WATER MAIN  WS WS WS WS PROPOSED WATER SERVICE	١٤
CONTRACTOR SHALL ALSO BE RESPONSIBLE FOR REMOVING ANY EXCESS MATERIALS AT THE SITE AND MAINTAINING ALL SEEDED AND MULCHED AREAS UNTIL PROJECT COMPLETION AND FINAL INSPECTION PER KDOT SPEC. 212. A	STORM & SANITARY NOTES			PROPOSED STORM SEWER  — — — — — — — — — PROPOSED UNDERDRAIN	
RESIDENTIAL YARD SHALL BE RESTORED WITHIN TWENTY-ONE (21) DAYS AFTER CONSTRUCTION.	4 ALL CTORM AND CANITARY ITEMS CHALL BE IN ACCORDANCE WITH THE			PROPOSED UNDERDRAIN / DOWNSPOUT COLLECTOR COMBO PROPOSED SANITARY SEWER	
ALL APPLICABLE RECOMMENDATIONS IN KENTUCKY'S BEST MANAGEMENT PRACTICES MANUAL SHALL BE FOLLOWED BY THE CONTRACTOR, INCLUDING SEEDING OF DISTURBED GROUND.	ALL STORM AND SANITARY ITEMS SHALL BE IN ACCORDANCE WITH THE LATEST SPECIFICATIONS AND DETAILS FROM SD1. CONCRETE AND METAL PIPE MATERIALS SHALL NOT BE USED UNLESS OTHERWISE SPECIFIED ON THESE PLANS.		EROSION CONTROL LEGEND	FM FM PROPOSED SANITARY FORCE MAIN  PROPOSED FIBER OPTICS  PROPOSED FIBER OPTICS	z
RIGHT-OF-WAY AND PROPERTY LINES SHOWN ARE PLOTTED FROM CAMPBELL COUNTY G.I.S. MAPPING AND ARE APPROXIMATE AND NOT THE RESULT OF A	2. CONTRACTOR SHALL BE REQUIRED TO MAINTAIN STORM AND SANITARY SEWER FLOW THROUGHOUT THE PROJECT, FOR THE DURATION OF		(IP) INLET PROTECTION (SEE DETAIL)	—————————————————————————————————————	N
FIELD BOUNDARY SURVEY.  THE CONTRACTOR SHALL LIMIT THEIR WORK AREA TO THE EASEMENTS AND RIGHTS-OF-WAY SHOWN ON THESE PLANS UNLESS WRITTEN PERMISSION IS	CONSTRUCTION. ALL COST FOR THE ABOVE SHALL BE INCIDENTAL TO THE CONTRACT.			——————————————————————————————————————	
GIVEN BY THE PROPERTY OWNER AND APPROVED BY THE CITY OF FORT THOMAS.	3. IF REQUIRED, CONTRACTOR SHALL BE RESPONSIBLE FOR CONTACTING AND SCHEDULING STORM AND SANITARY SEWER INSPECTIONS AS SET OUT IN THE PRECONSTRUCTION MEETING.			PROPOSED EASEMENT  PROPOSED GUARDRAIL	
ALL OSHA, STATE AND LOCAL SAFETY REGULATIONS SHALL BE FOLLOWED DURING CONSTRUCTION.	4. CONNECTIONS INTO EXISTING OR PROPOSED STORM OR SANITARY SEWER STRUCTURES OR PIPES SHALL BE COMPLETED BY A CERTIFIED			PROPOSED TREE LINE / CLEARING LIMITS  PROPOSED DISTURBED LIMITS	
RELOCATION OR REINSTALLATION OF EXISTING MAIL BOXES, FENCES, PRIVATE LANDSCAPE LIGHTS, PRIVATE SIGNS, STREET SIGNS, RESTORATION OF LANDSCAPING AND TREATMENT OF EXISTING WALLS WHERE A PORTION HAS	TAPPER BY SD1.			PROPOSED FLAGPOLE  EXISTING FLAGPOLE	7
BEEN REMOVED SHALL BE INCIDENTAL TO CLEARING AND GRUBBING.  NO CONSTRUCTION SHALL COMMENCE UNTIL ALL CAMPBELL COUNTY AND THE				PROPOSED MAILBOX   Head   He	1" = 4 HCU
CITY OF FORT THOMAS PERMITS HAVE BEEN ISSUED AS REQUIRE  THE CONTRACTOR SHALL COORDINATE ALL WORK WITHIN THE PUBLIC RIGHT				EXISTING SIGN  PROPOSED CABLE PEDESTAL  EXISTING CABLE PEDESTAL  PROPOSED ELECTRIC PEDESTAL	.: .: .:
OF WAY WITH THE CITY OF FORT THOMAS. LOCAL TRAFFIC MUST BE MAINTAINED AT ALL TIMES DURING CONSTRUCTION UNLESS OTHERWISE NOTED IN THESE PLANS.	WATER NOTES			EP EXISTING ELECTRIC PEDESTAL  PROPOSED PULL BOX  PB EXISTING PULL BOX	JED 1 C.
ADDITIONAL BMP'S AND EROSION AND SEDIMENT CONTROL MEASURES MAY BE REQUIRED AS DEEMED NECESSARY. ALL COST FOR ABOVE SHALL BE INCLUDED IN LUMP SUM BID FOR EROSION CONTROL AND WATER POLLUTION	ALL WORK RELATING TO WATER MAINS OR WATER SERVICE LINES     SHALL BE COMPLETED IN ACCORDANCE WITH THE RULES AND     REGULATIONS OF THE NORTHERN KENTUCKY WATER DISTRICT (NKWD).			で PROPOSED GROUND LIGHT	ISS SCA
CONTROL.  LIMITS OF DRIVEWAY APRON & SIDEWALK REPLACEMENT TO BE MARKED IN	2. CONTRACTOR MAY NOT USE WATER FROM FIRE HYDRANTS WITHOUT PRIOR PERMISSION FROM NKWD			PROPOSED ELECTRIC METER  EM EXISTING ELECTRIC METER	
THE FIELD BY THE ENGINEER. ADDITIONAL DRIVEWAY & SIDEWALK REPLACEMENTS, NOT SHOWN ON THE PLANS MAY BE REQUIRED BY THE ENGINEER.				PRPOSED ELECTRIC MANHOLE  EXISTING ELECTRIC MANHOLE  PROPOSED GAS METER	.
				©M EXISTING GAS METER  ⊗GV PROPOSED GAS VALVE   ■ PROPOSED CAS POY	14
				FXISTING GAS BOX  GF PROPOSED GAS BOX  PROPOSED UTILITY POLE	<b>5. 7. 8. 9. 1. 1. 1. 1. 1. 1. 1. 1</b>
	1. ALL WORK RELATING TO GAS MAINS OR GAS SERVICE LINES SHALL BE		HATCH LEGEND	EXISTING UTILITY POLE  ( PROPOSED GUY WIRE / ANCHOR  PROPOSED SANITARY MANHOLE	N N N
	COMPLETED IN ACCORDANCE WITH THE RULES AND REGULATIONS OF THE DUKE ENERGY		2" ASPHALT MILL AND OVERLAY	© EXISTING SANITARY MANHOLE  SCO EXISTING SANITARY CLEANOUT  SCO PROPOSED SANITARY CLEANOUT	PR THO THO THO THO
			2 ASI FIALI WILL AND OVERLAT	PROPOSED STORM MANHOLE  EXISTING STORM MANHOLE  PROPOSED STORM MANHOLE  PROPOSED SINGLE / DOUBLE CURB INLET	R F F
				EXISTING SINGLE / DOUBLE CURB INLET  PROPOSED CATCH BASIN	
				ODCO PROPOSED STORM CLEANOUT  O PROPOSED TELEPHONE MANHOLE	
				EXISTING TELEFTIONE FEDESTAL	A F F F F F F F F F F
	ELECTRIC NOTES			© PROPOSED FIRE HYDRANT PROPOSED WATER METER	S C C A N
	ALL WORK RELATING TO ELECTRIC LINES SHALL BE COMPLETED IN			EXISTING WATER VALVE	у К К Ш
	ACCORDANCE WITH THE RULES AND REGULATIONS OF THE DUKE ENERGY			REMOVE EXISTING BUSH / TREE  PROPOSED SLOPE DIRECTION	•
				EXISTING SURVEY BENCHMARK  TEST BORING LOCATION	
					PROJECT NO. <b>240102</b>
					DISCIPLINE
					SHEET NAME
					NOTES

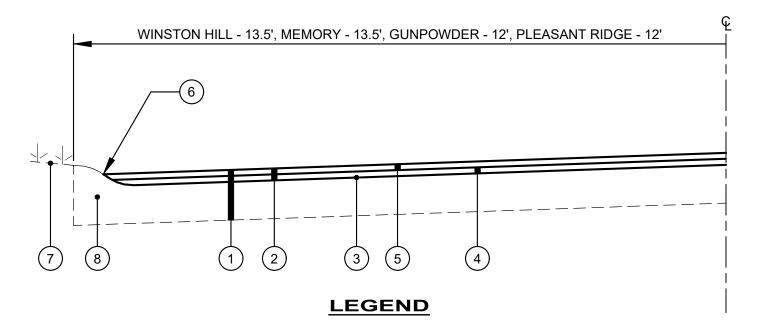


- (1) EXISTING PAVEMENT (CONCRETE OR ASPHALT) WITH ASPHALT OVERLAY
- $\fbox{2}$  ITEM 408 ASPHALT MILLING (2"  $\pm$  ) (IF STREET HAS CONCRETE BASE, REMOVE TO EXISTING CONCRETE SURFACE)
- (3) ITEM 406 TACK COAT @ 0.1 GAL/SY (INCIDENTAL TO ASPHALT PAVEMENT)
- (4) ITEM 402/403 BITUMINOUS ASPHALT PAVEMENT LEVELING COURSE (SCRATCH COAT) (3/4")
- 5 ITEM 402/403 BITUMINOUS ASPHALT PAVEMENT SURFACE WITH FIBER REINFORCEMENT (ACE FIBER OR APPROVED EQUAL) (1-1/4")
- 6 HOT APPLIED RUBBERIZED JOINT SEALER WHERE ASPHALT MEETS CURB FOLLOWING THE PLACEMENT OF SURFACE COURSE (INCIDENTAL TO ASPHALT PAVEMENT)
- 7 DO NOT DISTURB YARD AREA
- 8 EXISTING CURB (REMOVE AND REPLACE AS NEEDED, BY OTHERS)

# **TYPICAL PAVEMENT SECTION**

N.T.S.

GUNPOWDER RIDGE, MEMORY LANE, WINSTON HILL, PLEASANT RIDGE

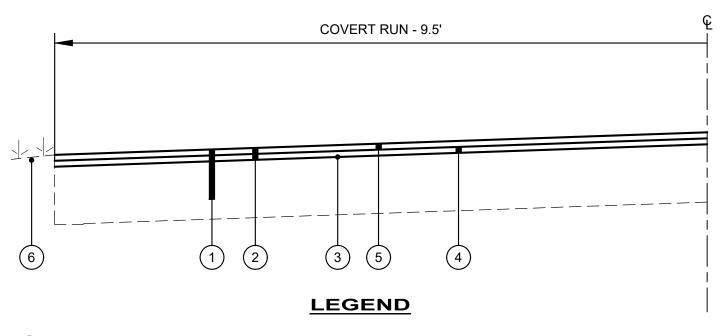


- (1) EXISTING PAVEMENT (CONCRETE OR ASPHALT) WITH ASPHALT OVERLAY
- 2 ITEM 408 ASPHALT MILLING (2"  $\pm$  ) (IF STREET HAS CONCRETE BASE, REMOVE TO EXISTING CONCRETE SURFACE)
- (3) ITEM 406 TACK COAT @ 0.1 GAL/SY (INCIDENTAL TO ASPHALT PAVEMENT)
- (4) ITEM 402/403 BITUMINOUS ASPHALT PAVEMENT LEVELING COURSE (SCRATCH COAT) (3/4")
- (5) ITEM 402/403 BITUMINOUS ASPHALT PAVEMENT SURFACE WITH FIBER REINFORCEMENT (ACE FIBER OR APPROVED EQUAL) (1-1/4")
- 6 DO NOT DISTURB YARD AREA

# **TYPICAL PAVEMENT SECTION**

NTS

COVERT RUN PIKE

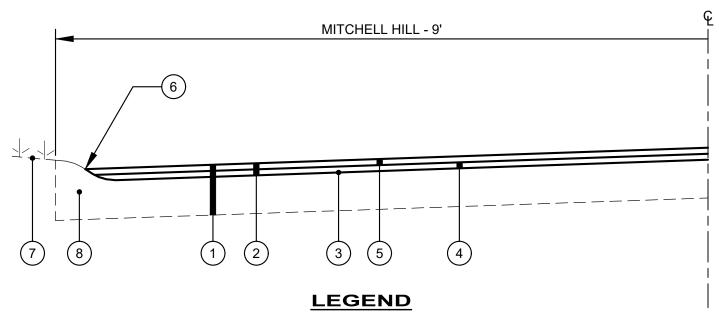


- (1) EXISTING PAVEMENT (CONCRETE OR ASPHALT) WITH ASPHALT OVERLAY
- 2 ITEM 408 ASPHALT MILLING (2" ± ) (IF STREET HAS CONCRETE BASE, REMOVE TO EXISTING CONCRETE SURFACE)
- (3) ITEM 406 TACK COAT @ 0.1 GAL/SY (INCIDENTAL TO ASPHALT PAVEMENT)
- (4) ITEM 402/403 BITUMINOUS ASPHALT PAVEMENT LEVELING COURSE (SCRATCH COAT) (3/4")
- 5 ITEM 402/403 BITUMINOUS ASPHALT PAVEMENT SURFACE WITH FIBER REINFORCEMENT (ACE FIBER OR APPROVED EQUAL) (1-1/4")
- 6 HOT APPLIED RUBBERIZED JOINT SEALER WHERE ASPHALT MEETS CURB FOLLOWING THE PLACEMENT OF SURFACE COURSE (INCIDENTAL TO ASPHALT PAVEMENT)
- 7 DO NOT DISTURB YARD AREA
- 8 EXISTING CURB (REMOVE AND REPLACE AS NEEDED, BY OTHERS)

# **TYPICAL PAVEMENT SECTION - ALTERNATE A & B**

N.T.S.

MITCHELL HILL

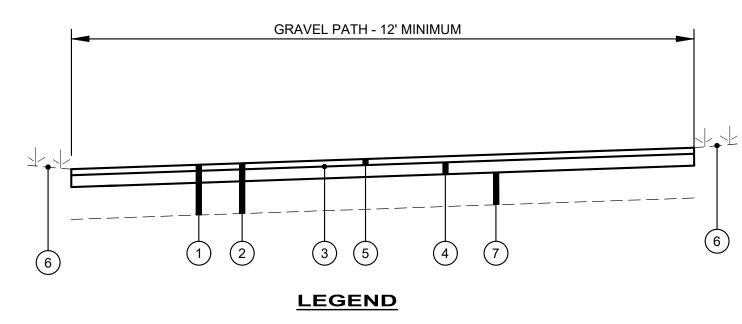


- EXISTING GRAVEL PAVEMENT
- 2 CUT 11.5" (BY OTHERS)
- (3) ITEM 406 TACK COAT @ 0.1 GAL/SY (INCIDENTAL TO ASPHALT PAVEMENT)
- (4) ITEM 402/403 BITUMINOUS ASPHALT PAVEMENT BASE COURSE (4")
- 5 ITEM 402/403 BITUMINOUS ASPHALT PAVEMENT SURFACE WITH FIBER REINFORCEMENT (ACE FIBER OR APPROVED EQUAL) (1-1/2")
- 6 DO NOT DISTURB YARD AREA (RESTORATION AS NECESSARY, INCIDENTAL TO CONTRACT)
- 7 6" STONE (BY OTHERS)


# **TYPICAL PAVEMENT SECTION - ALTERNATE C**

N.T.S.

MITCHELL HILL

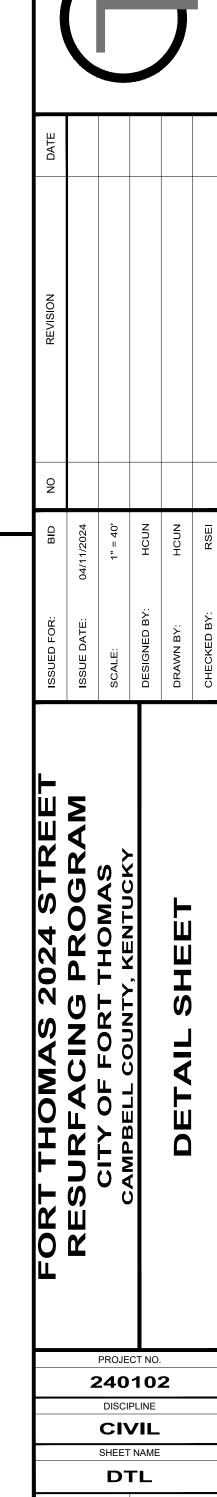

15

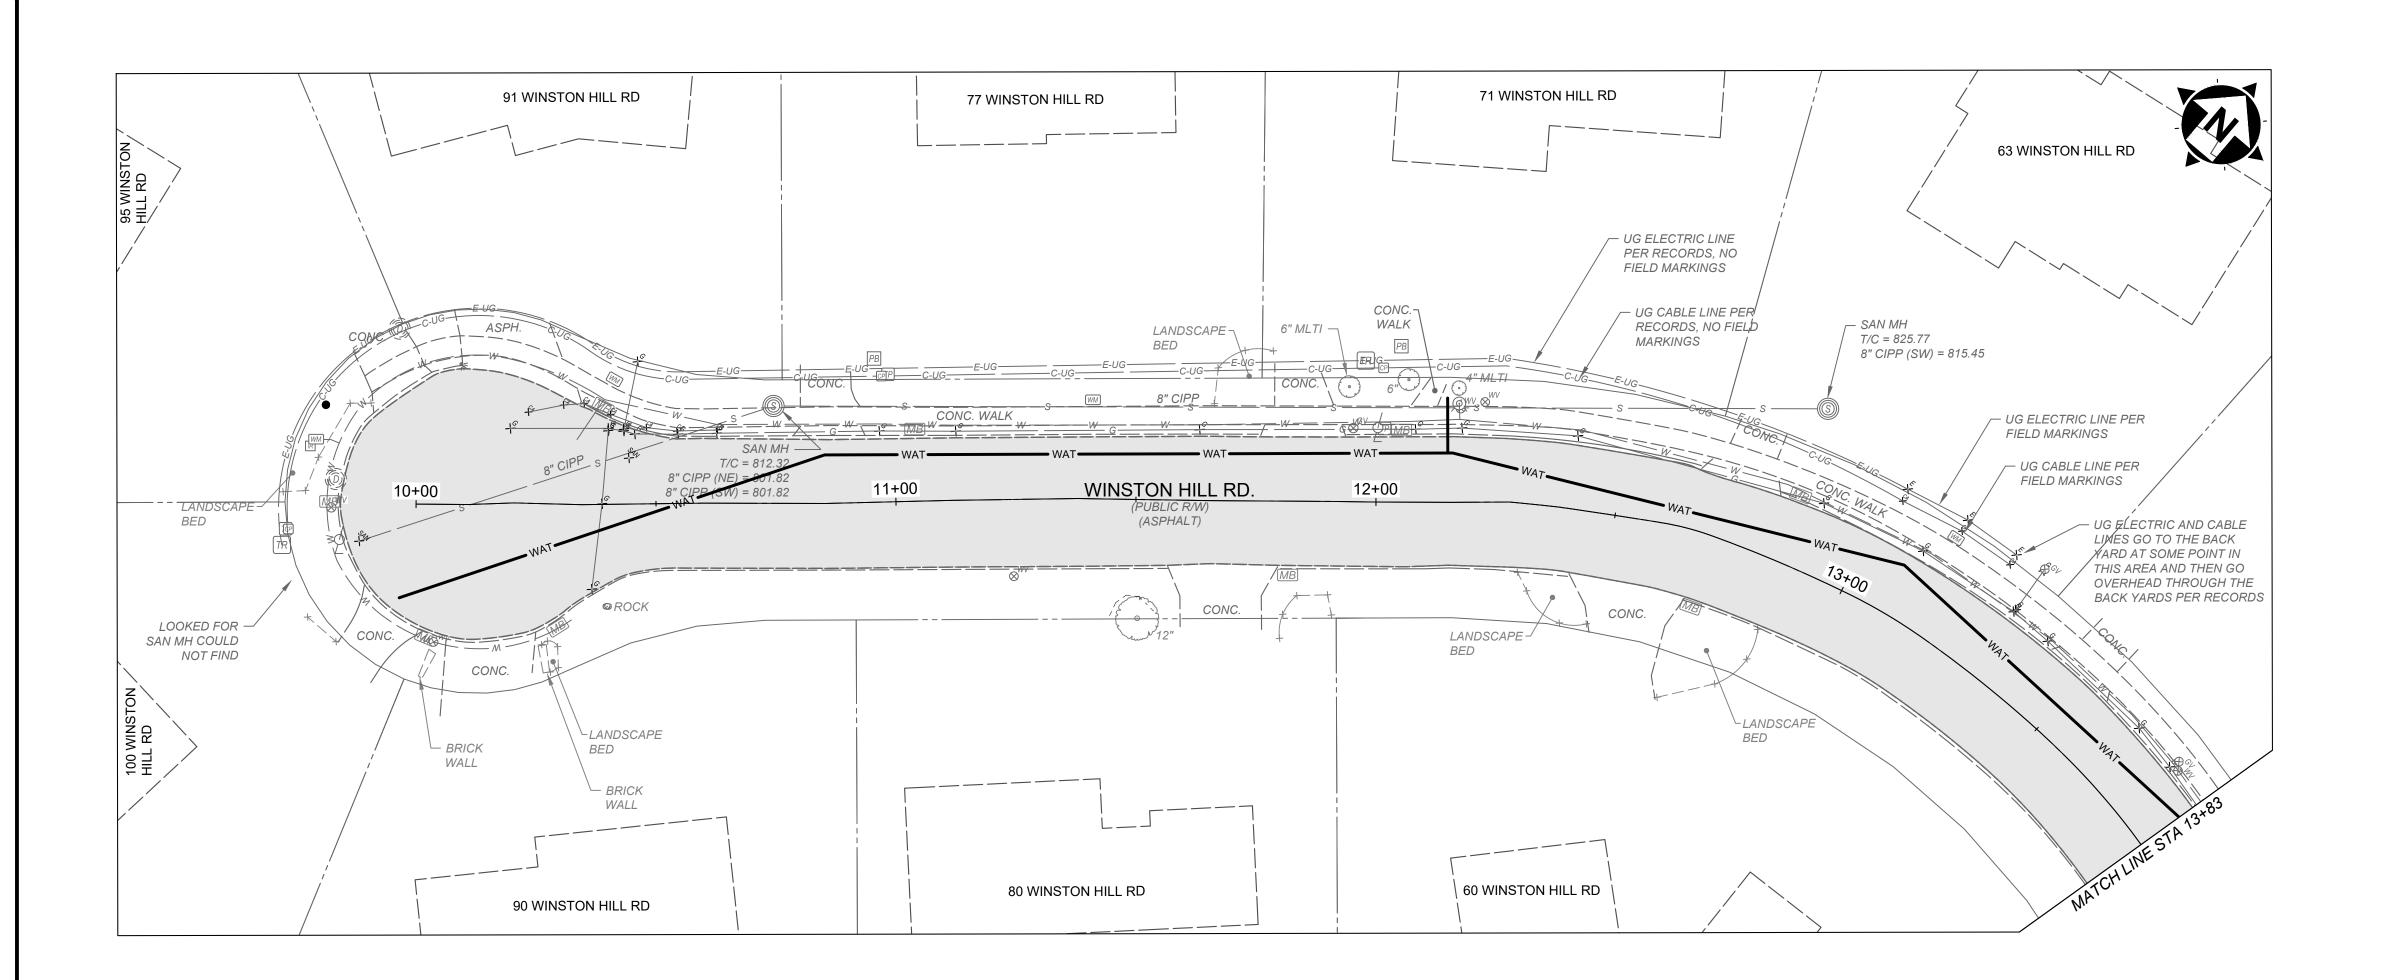



2" ASPHALT MILL AND OVERLAY

### NOTES

- THE FINAL FULL DEPTH REPAIR AREAS WILL BE MARKED WHEN THE PLANING OPERATIONS HAVE BEEN COMPLETED.
- 2. ADJUSTMENTS TO VALVE BOXES, METERS OR OTHER ASSOCIATED GAS, ELECTRIC, TELEPHONE, WATER, OR CABLE FACILITIES, IF NECESSARY, SHALL BE CONSIDERED INCIDENTAL TO THE CONTRACT AND SHALL BE COMPLETED PER UTILITY OWNER REQUIREMENTS.
- 3. RESTORE ALL DOWNSPOUT LINES IN CURB.
- 4. FINAL PAVEMENT ELEVATION AT CURB LINE SHALL NOT EXCEED THE EXITING ASPHALT ELEVATION AT CURB LINE.

#### CONSTRUCTION NOTES

- 1) ITEM SPL SANITARY MANHOLE ADJUSTED TO GRADE, PER SD1 REGULATIONS
- 2 ITEM 713 PAVEMENT MARKING STOP BAR (24" WHITE)
- (3) ITEM 713 PAVEMENT MARKING CROSSWALK (8" WHITE)
- 4 ITEM 713 PAVEMENT MARKING CENTERLINE




PROJECT NO.

240102

DISCIPLINE

CIVIL

PLN 01

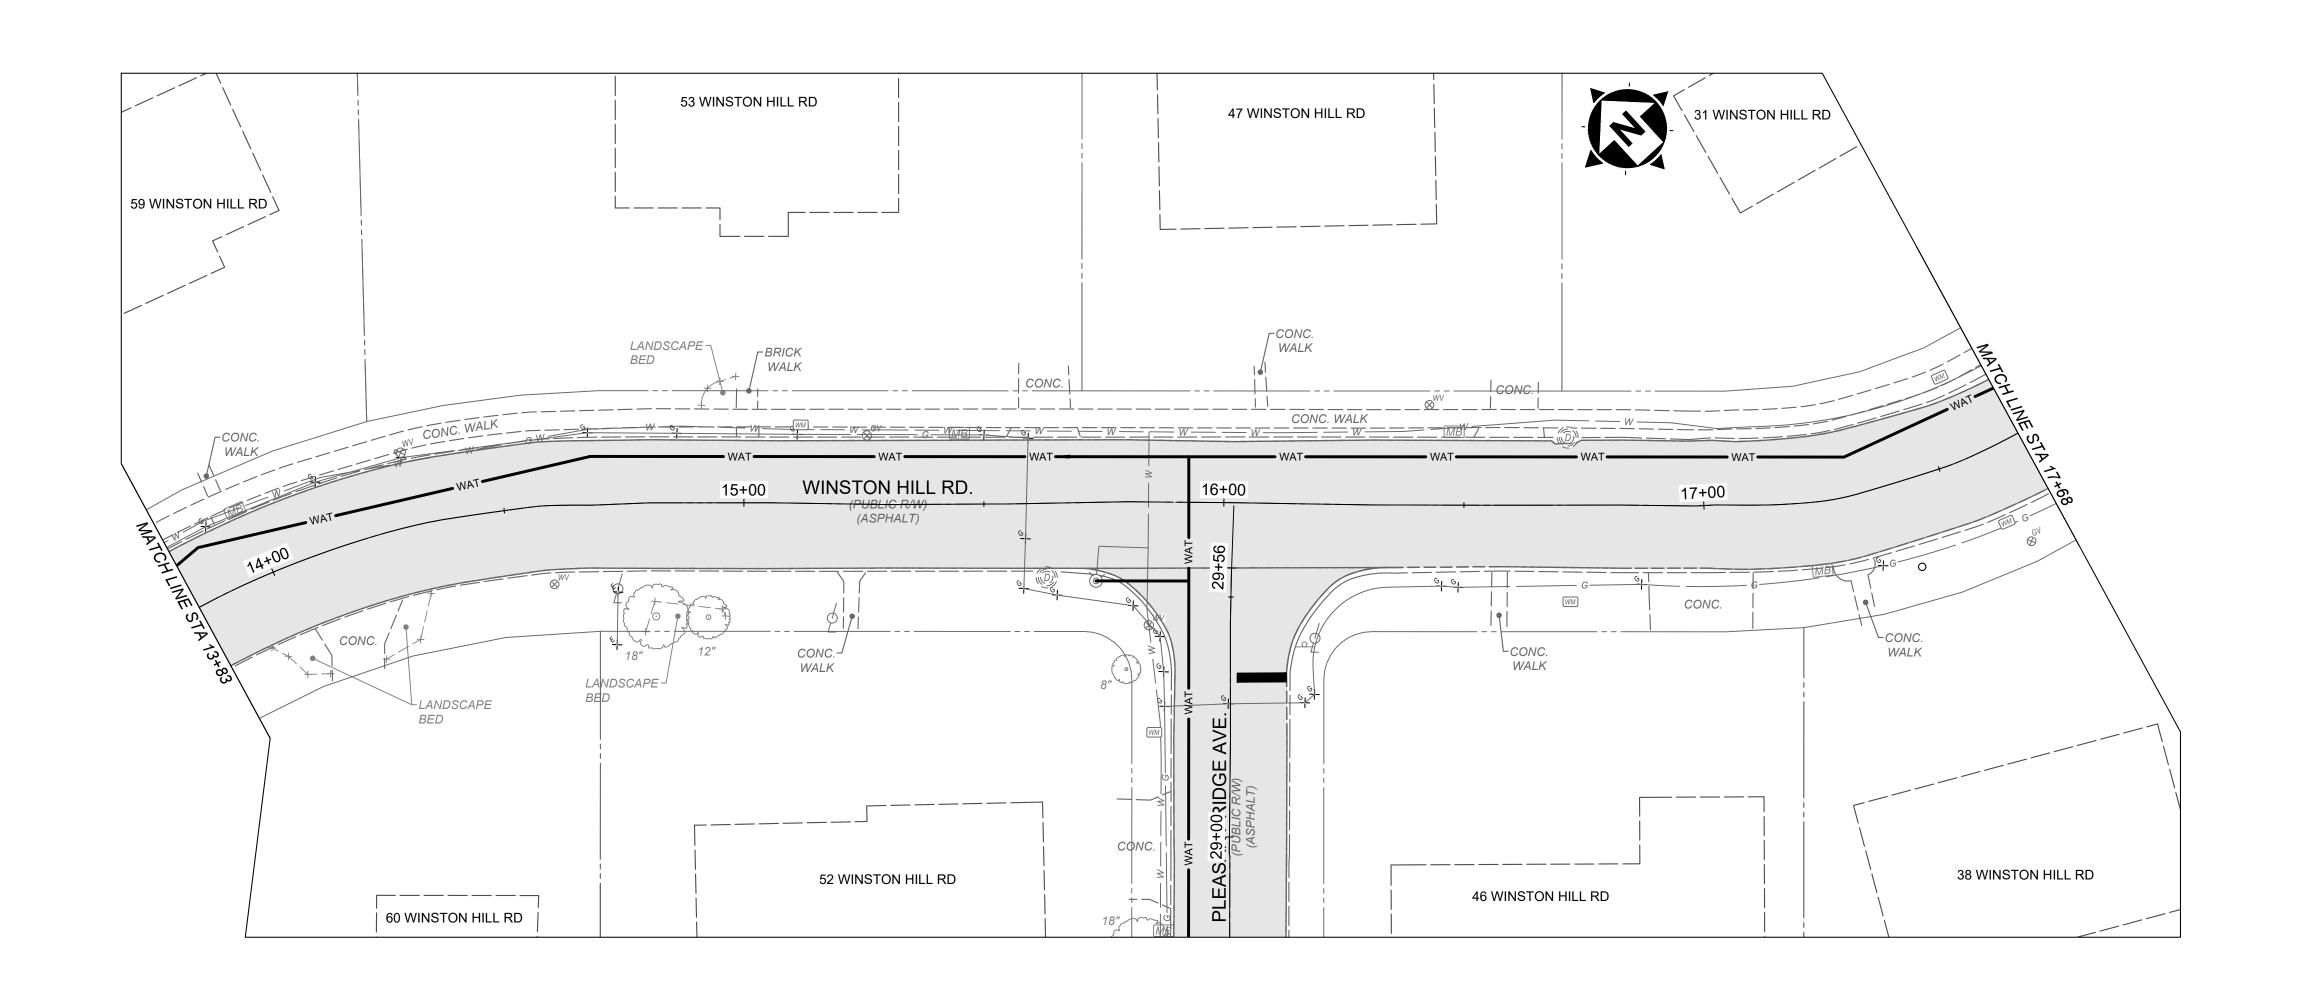



2" ASPHALT MILL AND OVERLAY


#### NOTES

- THE FINAL FULL DEPTH REPAIR AREAS WILL BE MARKED WHEN THE PLANING OPERATIONS HAVE BEEN COMPLETED.
- 2. ADJUSTMENTS TO VALVE BOXES, METERS OR OTHER ASSOCIATED GAS, ELECTRIC, TELEPHONE, WATER, OR CABLE FACILITIES, IF NECESSARY, SHALL BE CONSIDERED INCIDENTAL TO THE CONTRACT AND SHALL BE COMPLETED PER UTILITY OWNER REQUIREMENTS.
- 3. RESTORE ALL DOWNSPOUT LINES IN CURB.
- 4. FINAL PAVEMENT ELEVATION AT CURB LINE SHALL NOT EXCEED THE EXITING ASPHALT ELEVATION AT CURB LINE.

#### CONSTRUCTION NOTES

- 1 ITEM SPL SANITARY MANHOLE ADJUSTED TO GRADE, PER SD1 REGULATIONS
- (2) ITEM 713 PAVEMENT MARKING STOP BAR (24" WHITE)
- (3) ITEM 713 PAVEMENT MARKING CROSSWALK (8" WHITE)


  (4) ITEM 713 PAVEMENT MARKING CENTERLINE

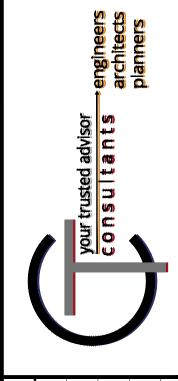

04/11/2024	1" = 40'	HCUN	HCUN	RSEI
ISSUE DATE:	SCALE:	DESIGNED BY:	DRAWN BY:	СНЕСКЕВ ВҮ:
Σ				68

CITY OF FORT THOMAS  CAMPBELL COUNTY, KENTUCKY	WINSTON HILL ROAD STA. 13+83 TO STA. 17+68
2401	
CIV	

PLN 02

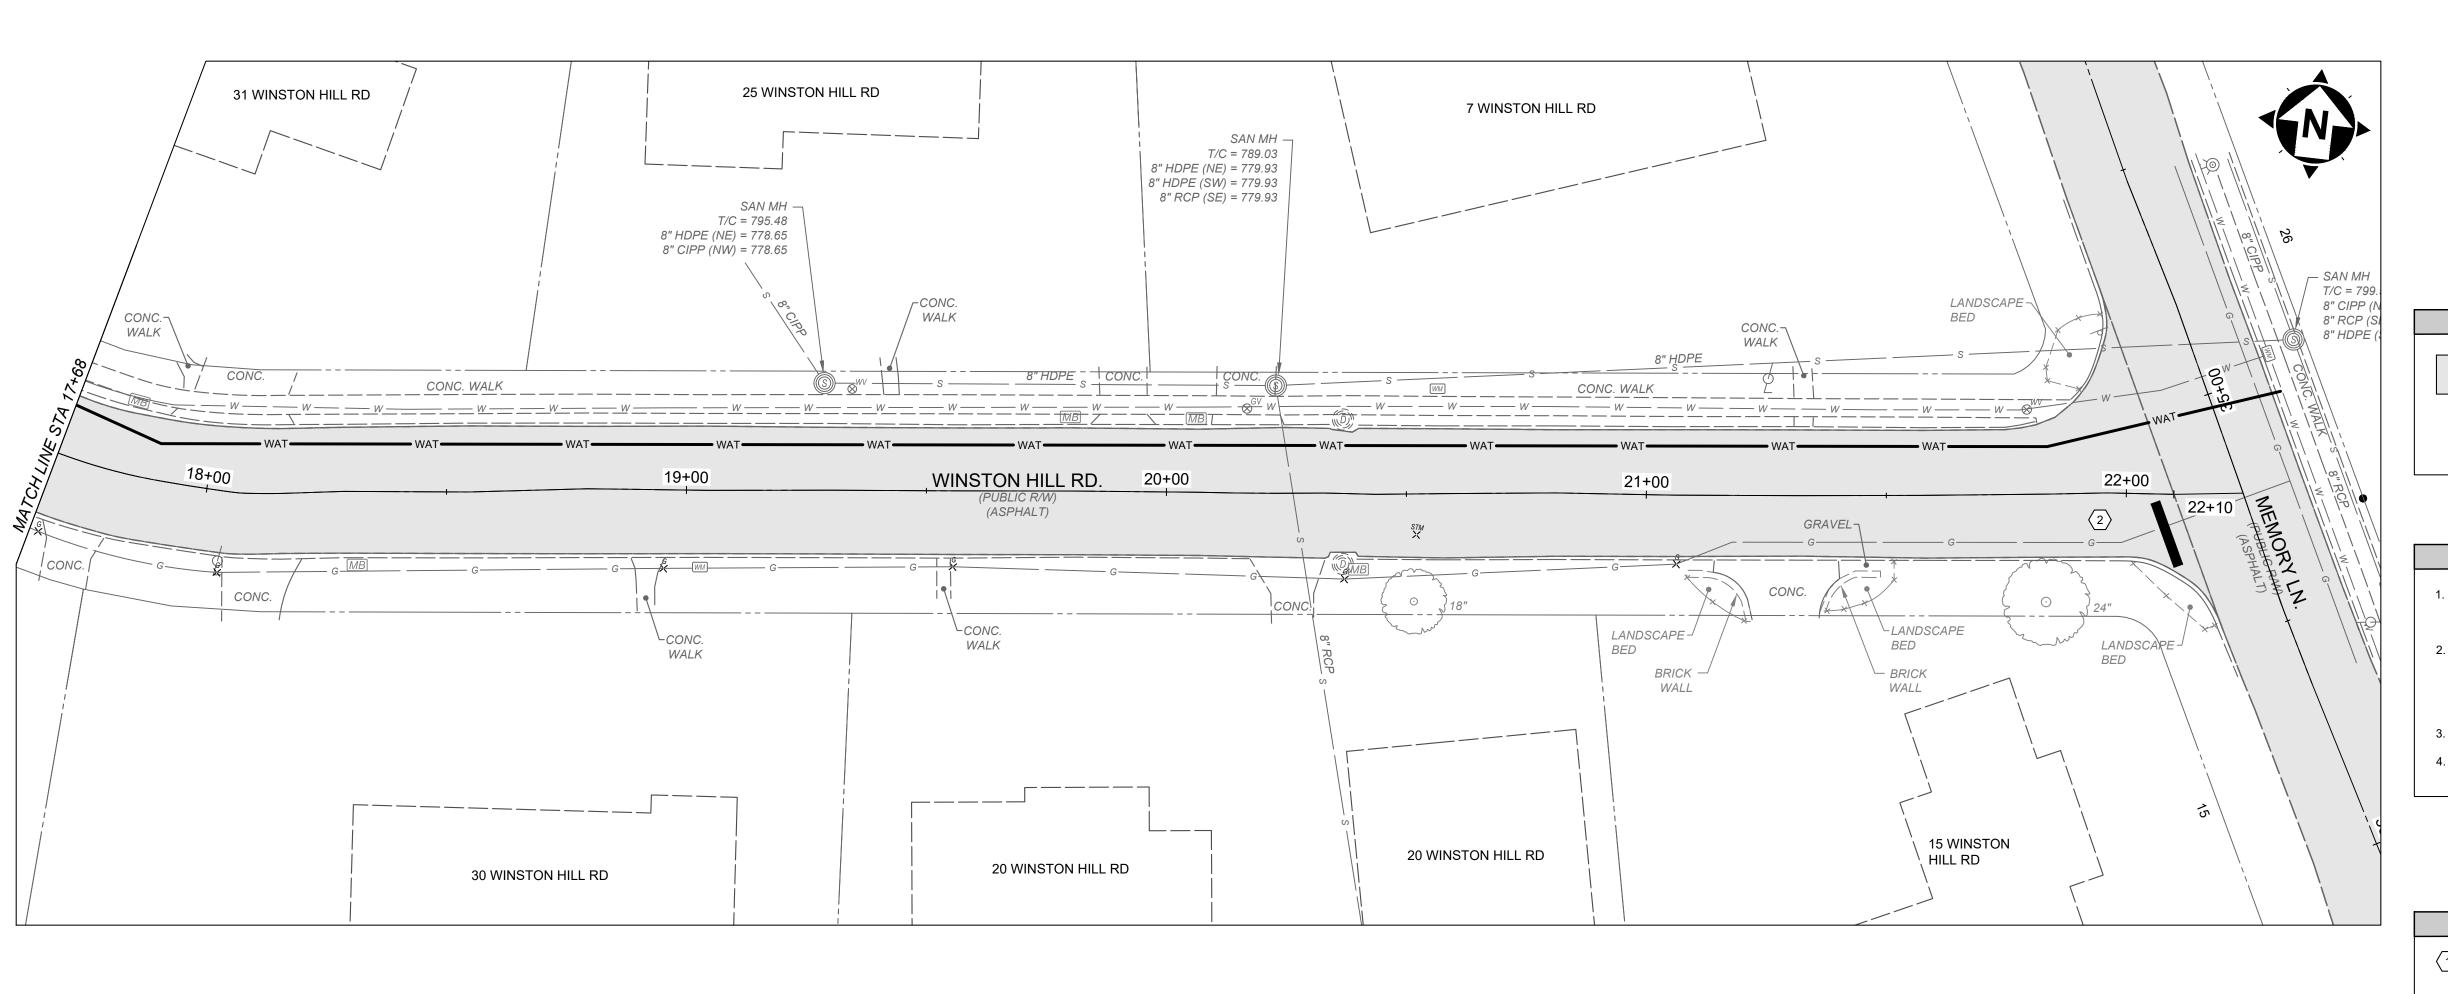




2" ASPHALT MILL AND OVERLAY

### NOTES

- THE FINAL FULL DEPTH REPAIR AREAS WILL BE MARKED WHEN THE PLANING OPERATIONS HAVE BEEN COMPLETED.
- 2. ADJUSTMENTS TO VALVE BOXES, METERS OR OTHER ASSOCIATED GAS, ELECTRIC, TELEPHONE, WATER, OR CABLE FACILITIES, IF NECESSARY, SHALL BE CONSIDERED INCIDENTAL TO THE CONTRACT AND SHALL BE COMPLETED PER UTILITY OWNER REQUIREMENTS.
- 3. RESTORE ALL DOWNSPOUT LINES IN CURB.
- 4. FINAL PAVEMENT ELEVATION AT CURB LINE SHALL NOT EXCEED THE EXITING ASPHALT ELEVATION AT CURB LINE.

#### CONSTRUCTION NOTES

- 1) ITEM SPL SANITARY MANHOLE ADJUSTED TO GRADE, PER SD1 REGULATIONS
- (2) ITEM 713 PAVEMENT MARKING STOP BAR (24" WHITE)
- (3) ITEM 713 PAVEMENT MARKING CROSSWALK (8" WHITE)
- 4 ITEM 713 PAVEMENT MARKING CENTERLINE

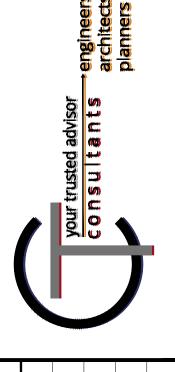

REVISION					
ON N					
BID	04/11/2024	1" = 40'	HCUN	HCUN	RSEI
ISSUED FOR:	ISSUE DATE:	SCALE:	DESIGNED BY:	DRAWN BY:	CHECKED BY:
_ _ U	Σ				<u> </u>

PROJECT NO.


240102


DISCIPLINE


CIVIL

PLN 03

0F **15** 

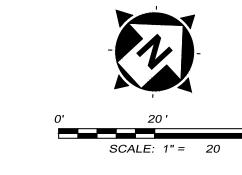

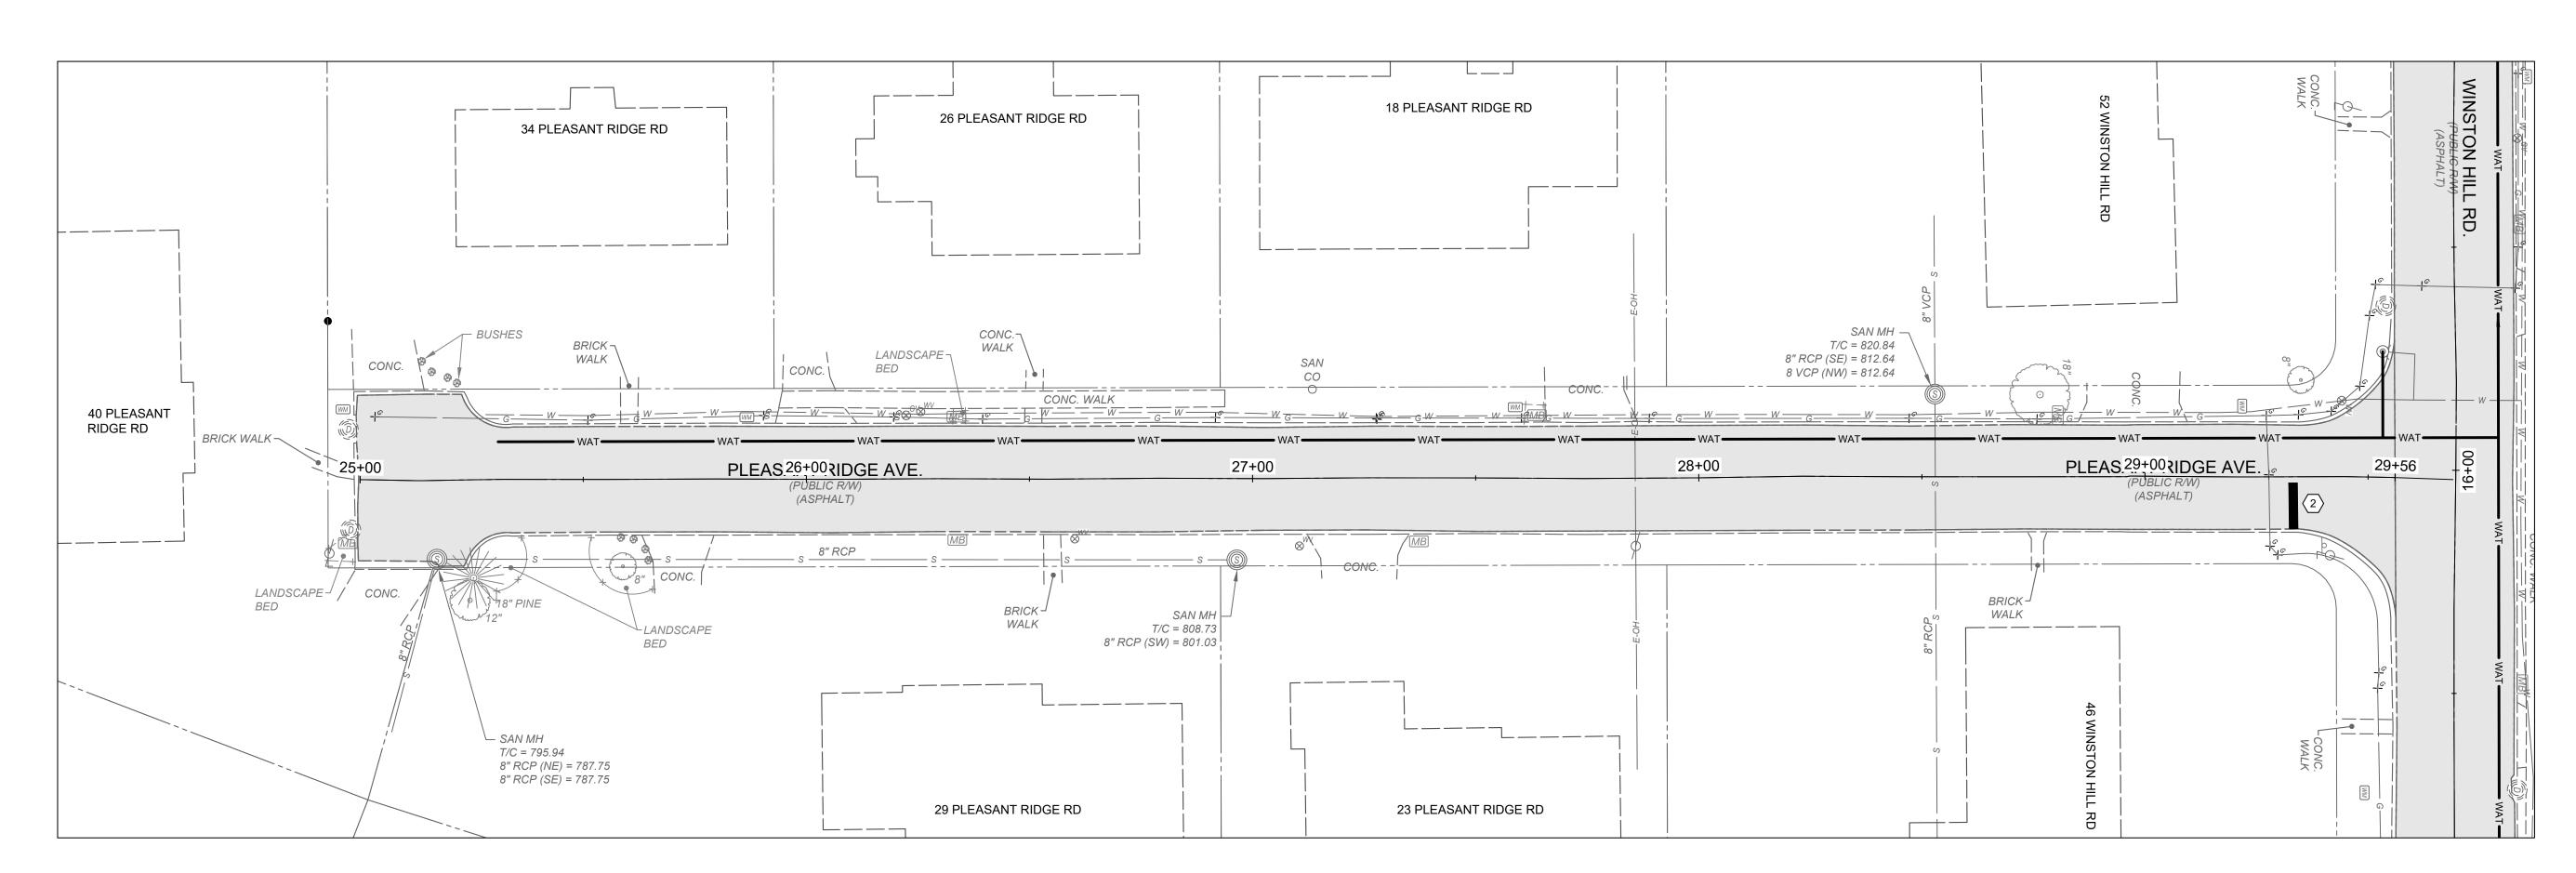

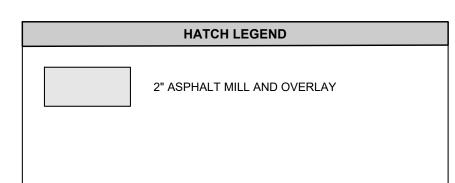

#### NOTES

- THE FINAL FULL DEPTH REPAIR AREAS WILL BE MARKED WHEN THE PLANING OPERATIONS HAVE BEEN COMPLETED.
- 2. ADJUSTMENTS TO VALVE BOXES, METERS OR OTHER ASSOCIATED GAS, ELECTRIC, TELEPHONE, WATER, OR CABLE FACILITIES, IF NECESSARY, SHALL BE CONSIDERED INCIDENTAL TO THE CONTRACT AND SHALL BE COMPLETED PER UTILITY OWNER REQUIREMENTS.
- 3. RESTORE ALL DOWNSPOUT LINES IN CURB.
- 4. FINAL PAVEMENT ELEVATION AT CURB LINE SHALL NOT EXCEED THE EXITING ASPHALT ELEVATION AT CURB LINE.

# CONSTRUCTION NOTES

- 1 ITEM SPL SANITARY MANHOLE ADJUSTED TO GRADE, PER SD1 REGULATIONS
- (2) ITEM 713 PAVEMENT MARKING STOP BAR (24" WHITE)
- 3 ITEM 713 PAVEMENT MARKING CROSSWALK (8" WHITE)
- 4 ITEM 713 PAVEMENT MARKING CENTERLINE

⇒engine archite planne						
d advisor						
your trusted advisor	•					
المالح ا	<b>†</b>					

ZAM ZAM	THOMAS SCALE:			HUD WORK
ISSUE DATE:	NLE:	DESIGNED BY:	DRAWN BY:	CHECKED BY:
04/11/2024	1" = 40'	HCUN	HCUN	RSEI


PROJECT NO. **240102** 

DISCIPLINE

SHEET NAME

**PLN 04** 

15

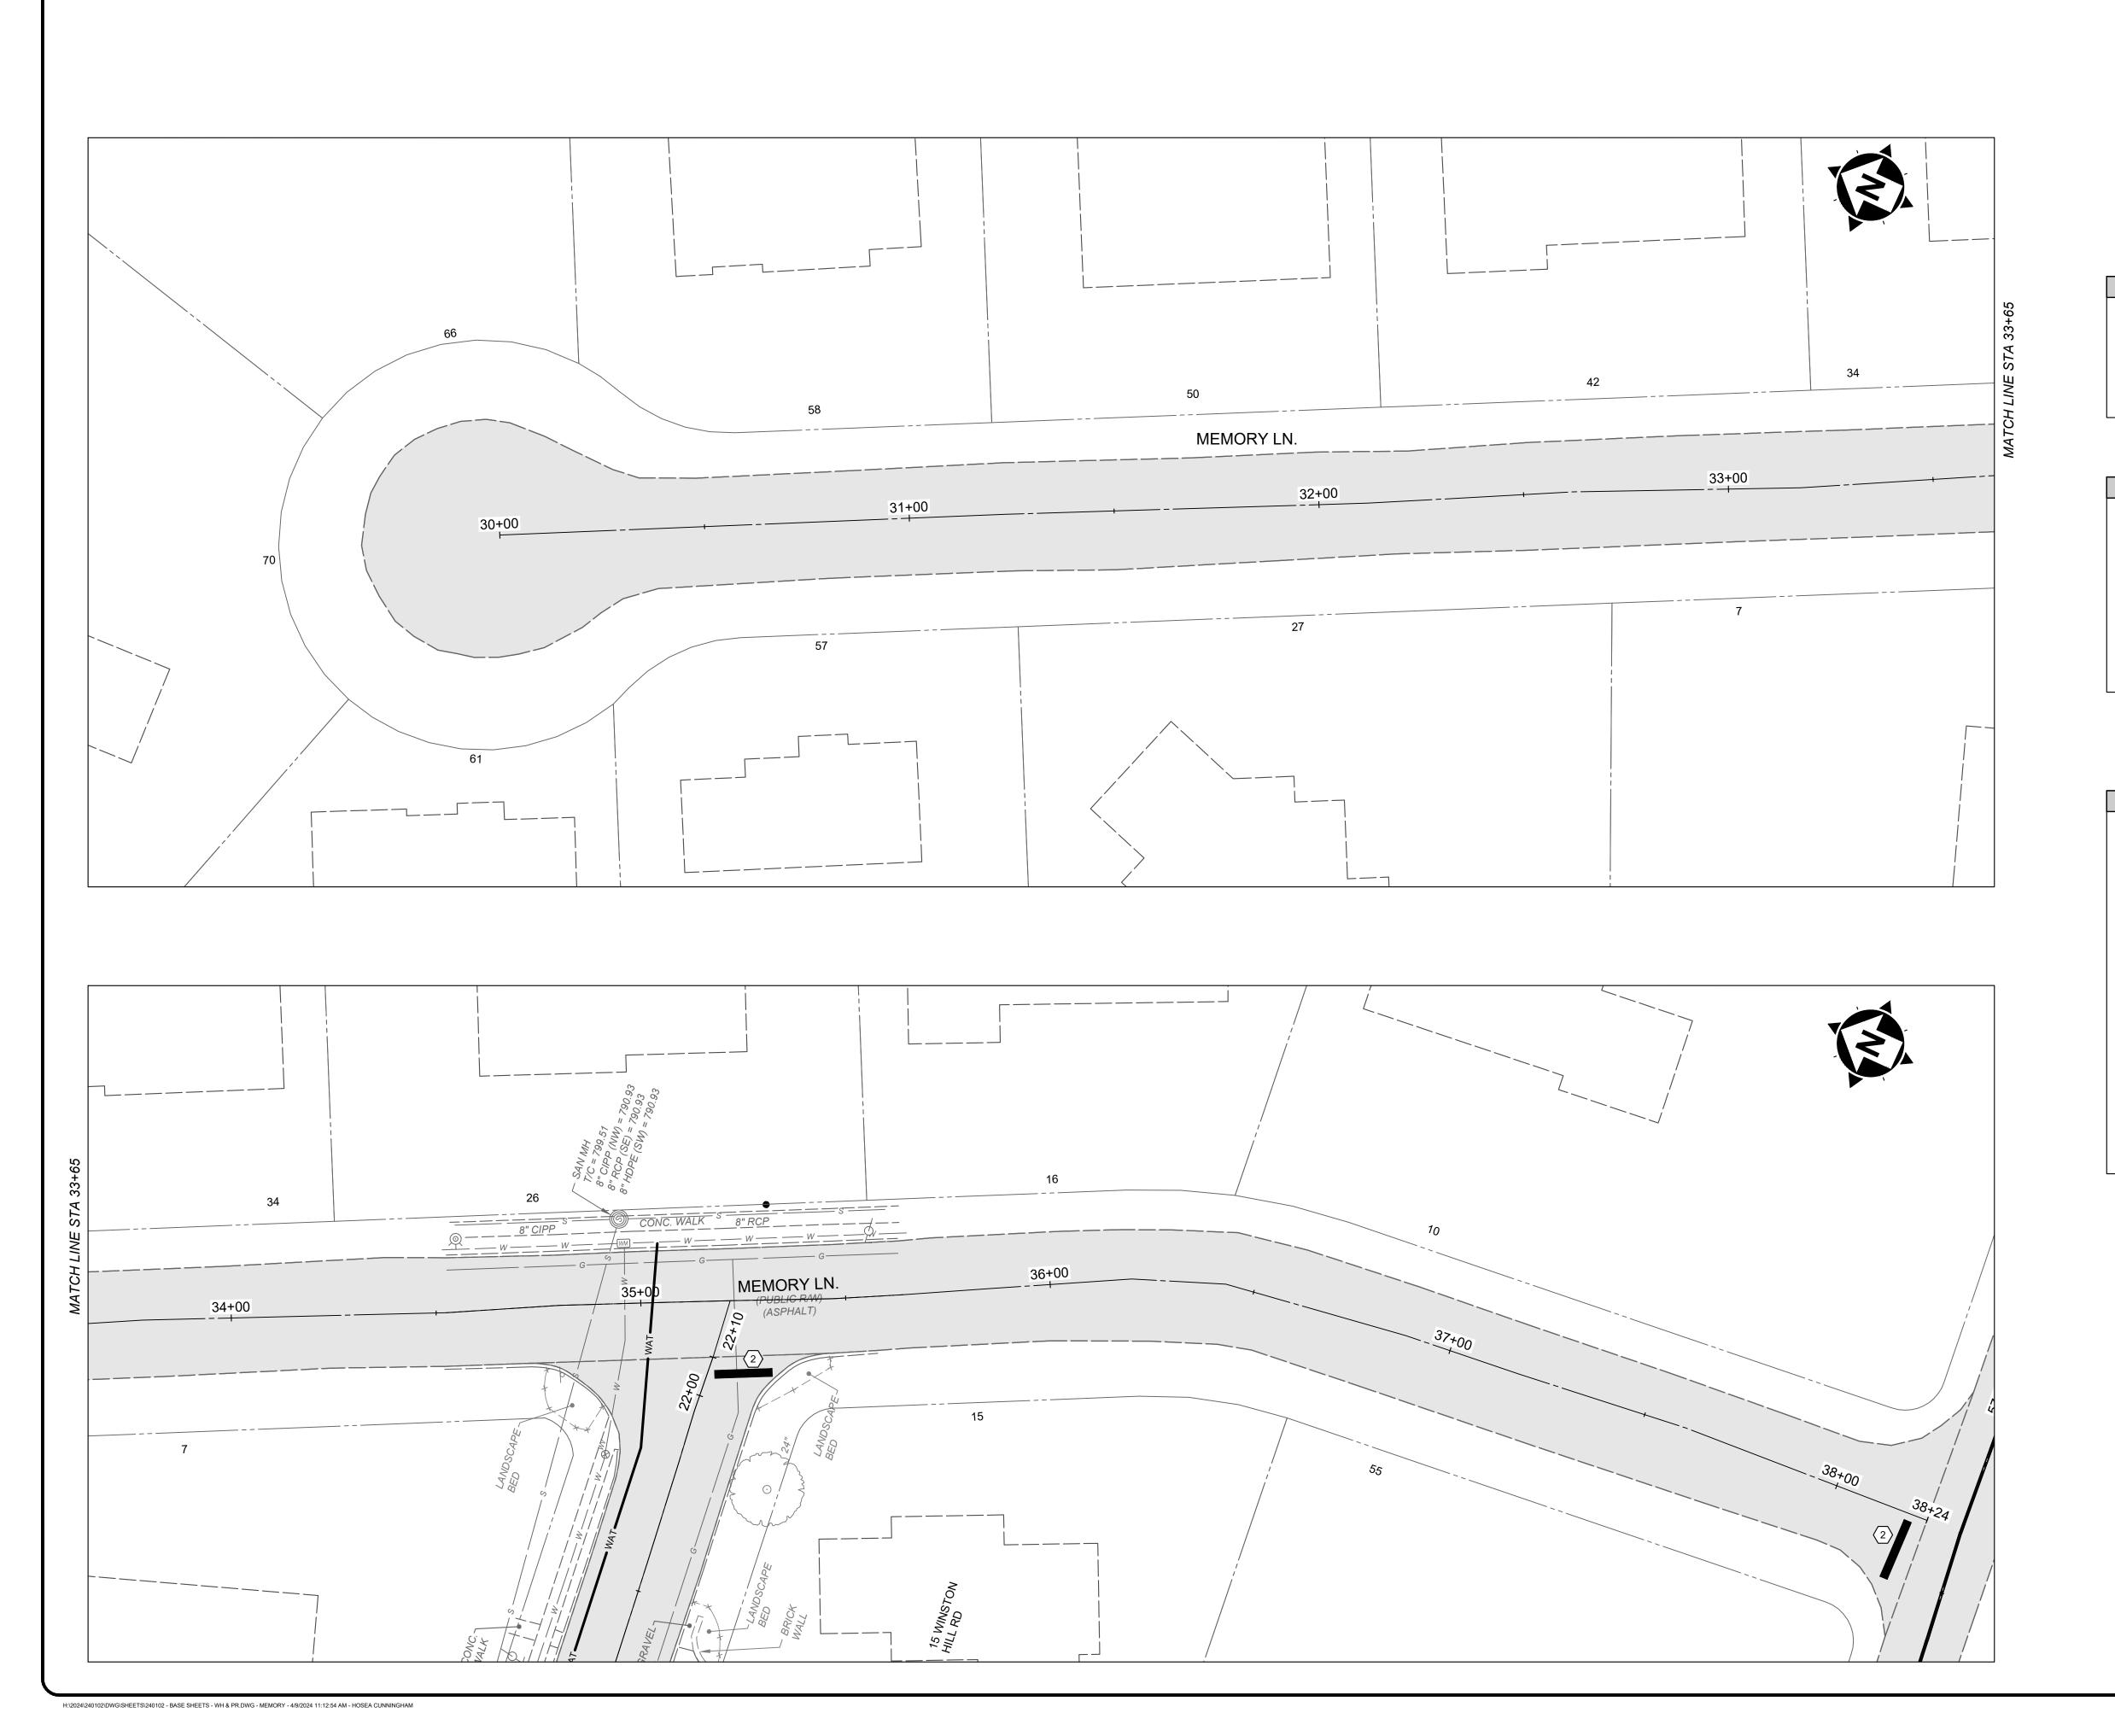




2" ASPHALT MILL AND OVERLAY

# NOTES

- THE FINAL FULL DEPTH REPAIR AREAS WILL BE MARKED WHEN THE PLANING OPERATIONS HAVE BEEN COMPLETED.
- 2. ADJUSTMENTS TO VALVE BOXES, METERS OR OTHER ASSOCIATED GAS, ELECTRIC, TELEPHONE, WATER, OR CABLE FACILITIES, IF NECESSARY, SHALL BE CONSIDERED INCIDENTAL TO THE CONTRACT AND SHALL BE COMPLETED PER UTILITY OWNER REQUIREMENTS.
- 3. RESTORE ALL DOWNSPOUT LINES IN CURB.
- 4. FINAL PAVEMENT ELEVATION AT CURB LINE SHALL NOT EXCEED THE EXITING ASPHALT ELEVATION AT CURB LINE.


#### CONSTRUCTION NOTES


- 1) ITEM SPL SANITARY MANHOLE ADJUSTED TO GRADE, PER SD1 REGULATIONS
- (2) ITEM 713 PAVEMENT MARKING STOP BAR (24" WHITE)
- (3) ITEM 713 PAVEMENT MARKING CROSSWALK (8" WHITE)
- 4 ITEM 713 PAVEMENT MARKING CENTERLINE

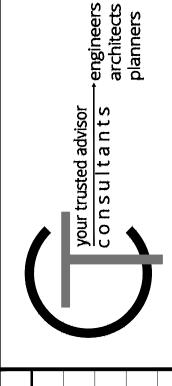

	FORT THOMAS 2024 STREET	ISSUED FOR:	BID
	Ш	ISSUE DATE:	04/11/2024
PROJE	CITY OF FORT THOMAS	SCALE:	1" = 40'
CT NO.		DESIGNED BY:	HCUN
	MEMORY LANE	DRAWN BY:	HCUN
	BEGIN WORK IO END WORK	CHECKED BY:	RSEI

240102
DISCIPLINE
CIVIL
SHEET NAME
PLN 05

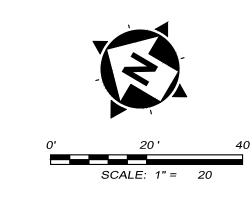

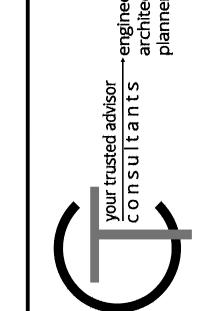

2" ASPHALT MILL AND OVERLAY

## NOTES

- THE FINAL FULL DEPTH REPAIR AREAS WILL BE MARKED WHEN THE PLANING OPERATIONS HAVE BEEN COMPLETED.
- ADJUSTMENTS TO VALVE BOXES, METERS OR OTHER ASSOCIATED GAS, ELECTRIC, TELEPHONE, WATER, OR CABLE FACILITIES, IF NECESSARY, SHALL BE CONSIDERED INCIDENTAL TO THE CONTRACT AND SHALL BE COMPLETED PER UTILITY OWNER REQUIREMENTS.
- 3. RESTORE ALL DOWNSPOUT LINES IN CURB.
- 4. FINAL PAVEMENT ELEVATION AT CURB LINE SHALL NOT EXCEED THE EXITING ASPHALT ELEVATION AT CURB LINE.
- 1) ITEM SPL SANITARY MANHOLE ADJUSTED TO GRADE, PER SD1 REGULATIONS
- (2) ITEM 713 PAVEMENT MARKING STOP BAR (24" WHITE)
- (3) ITEM 713 PAVEMENT MARKING CROSSWALK (8" WHITE)
- (4) ITEM 713 PAVEMENT MARKING DOUBLE YELLOW CENTERLINE

- (5) COOP LINE. FINAL LOCATION TO BE MARKED IN THE FIELD.
- 6 ITEM SPL FLEXAMAT SLOPE STABILIZATION. INCLUDES ANY CLEARING & GRUBBING & EXCAVATION.

DATE			
REVISION			
0			

₽¥Q	COVERT RUN PIKE
DES	
	CAMPBELL COUNTY, KENTUCKY
SCA	CITY OF FORT THOMAS
188I	KESUKFACING PROGRAM

RESURFACING PROGRAM CITY OF FORT THOMAS CAMPBELL COUNTY, KENTUCKY COVERT RUN PIKE BEGIN WORK TO STA, 43+75
--

PROJECT NO. 240102 DISCIPLINE CIVIL SHEET NAME **PLN 06** 

H:\2024\240102\DWG\SHEETS\240102 - BASE SHEETS - WH & PR.DWG - COVERT RUN - 4/9/2024 11:12:54 AM - HOSEA CUNNINGHAM


\_\_\_\_\_\_

141

42+00

**COVERT RUN PIKE** 

41+00

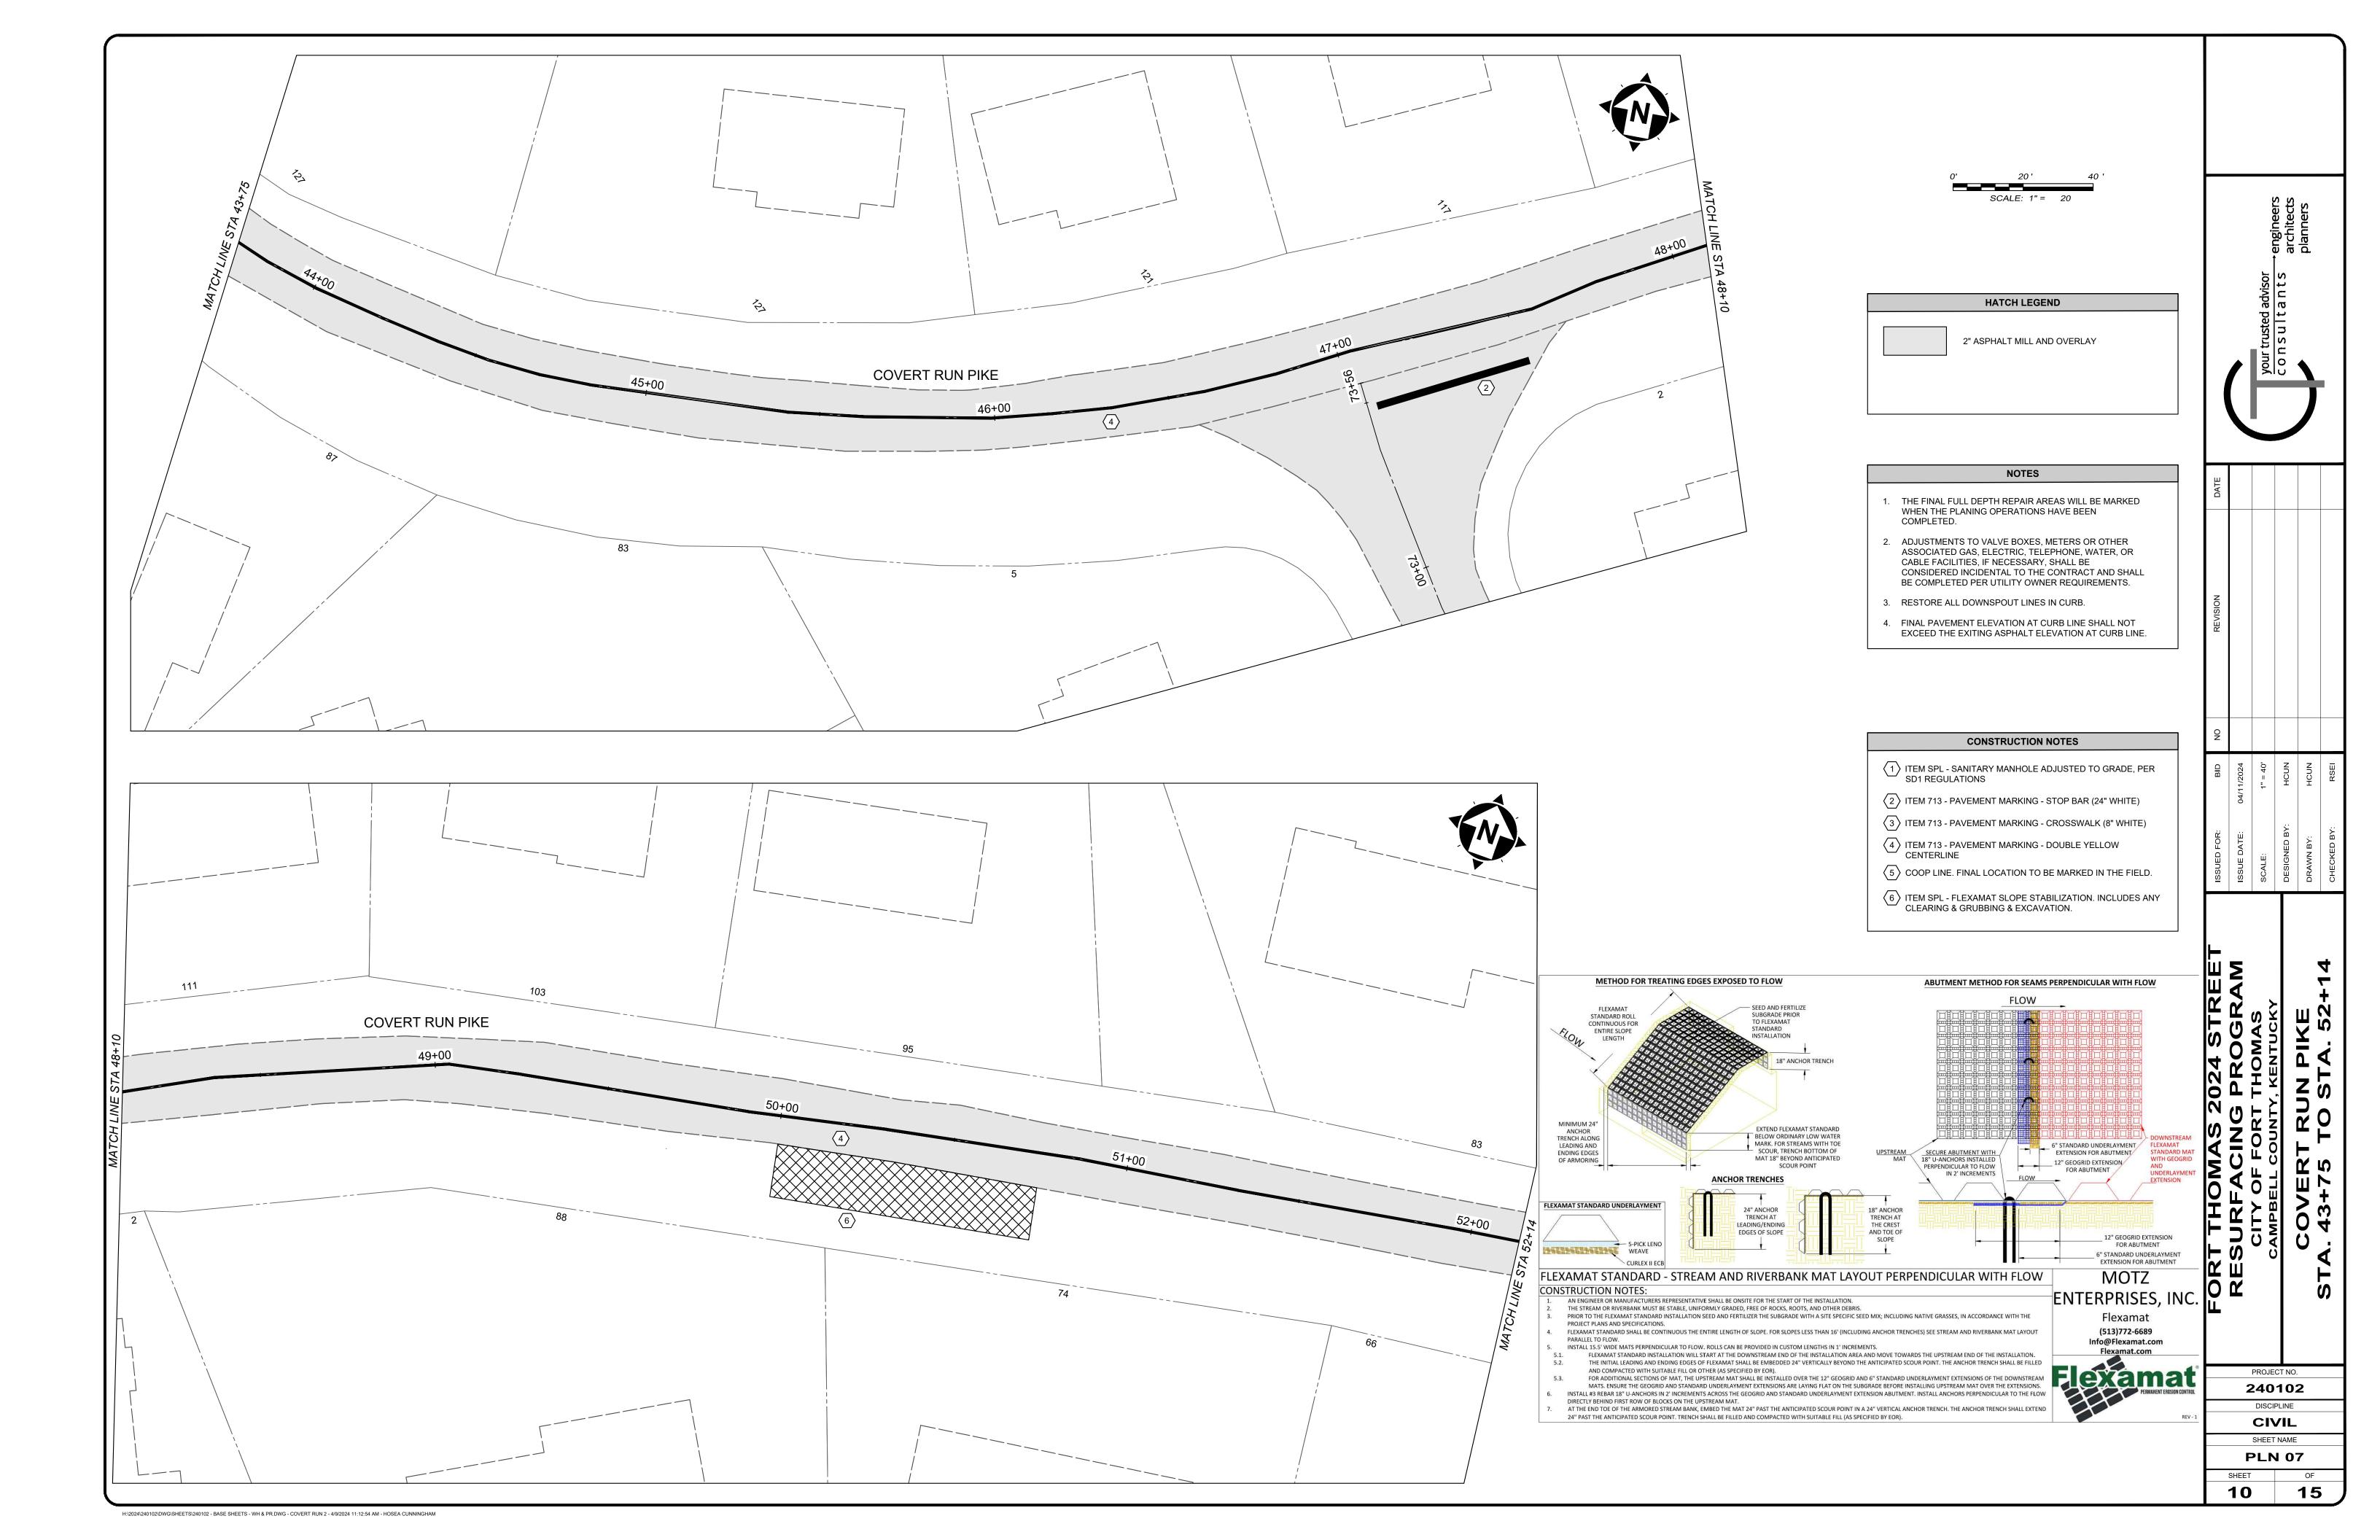



 $H:\ 2024\ 240102\ DWG\ SHEETS\ 240102-BASE\ SHEETS-WH\ \&\ PR.DWG-COVERT\ RUN\ 3-4/9/2024\ 11:12:54\ AM-HOSEA\ CUNNINGHAM$ 





2" ASPHALT MILL AND OVERLAY

#### NOTES


- THE FINAL FULL DEPTH REPAIR AREAS WILL BE MARKED WHEN THE PLANING OPERATIONS HAVE BEEN COMPLETED.
- 2. ADJUSTMENTS TO VALVE BOXES, METERS OR OTHER ASSOCIATED GAS, ELECTRIC, TELEPHONE, WATER, OR CABLE FACILITIES, IF NECESSARY, SHALL BE CONSIDERED INCIDENTAL TO THE CONTRACT AND SHALL BE COMPLETED PER UTILITY OWNER REQUIREMENTS.
- 3. RESTORE ALL DOWNSPOUT LINES IN CURB.
- 4. FINAL PAVEMENT ELEVATION AT CURB LINE SHALL NOT EXCEED THE EXITING ASPHALT ELEVATION AT CURB LINE.

#### CONSTRUCTION NOTES

- 1) ITEM SPL SANITARY MANHOLE ADJUSTED TO GRADE, PER SD1 REGULATIONS
- (2) ITEM 713 PAVEMENT MARKING STOP BAR (24" WHITE)
- (3) ITEM 713 PAVEMENT MARKING CROSSWALK (8" WHITE)
- 4 ITEM 713 PAVEMENT MARKING CENTERLINE

•	→erigineers architects	planners
your trusted advisor	consultants	<b>1</b>
		J


CING PROGRAM FORT THOMAS COUNTY, KENTUCKY WDER RIDGE RK TO END WORK
---

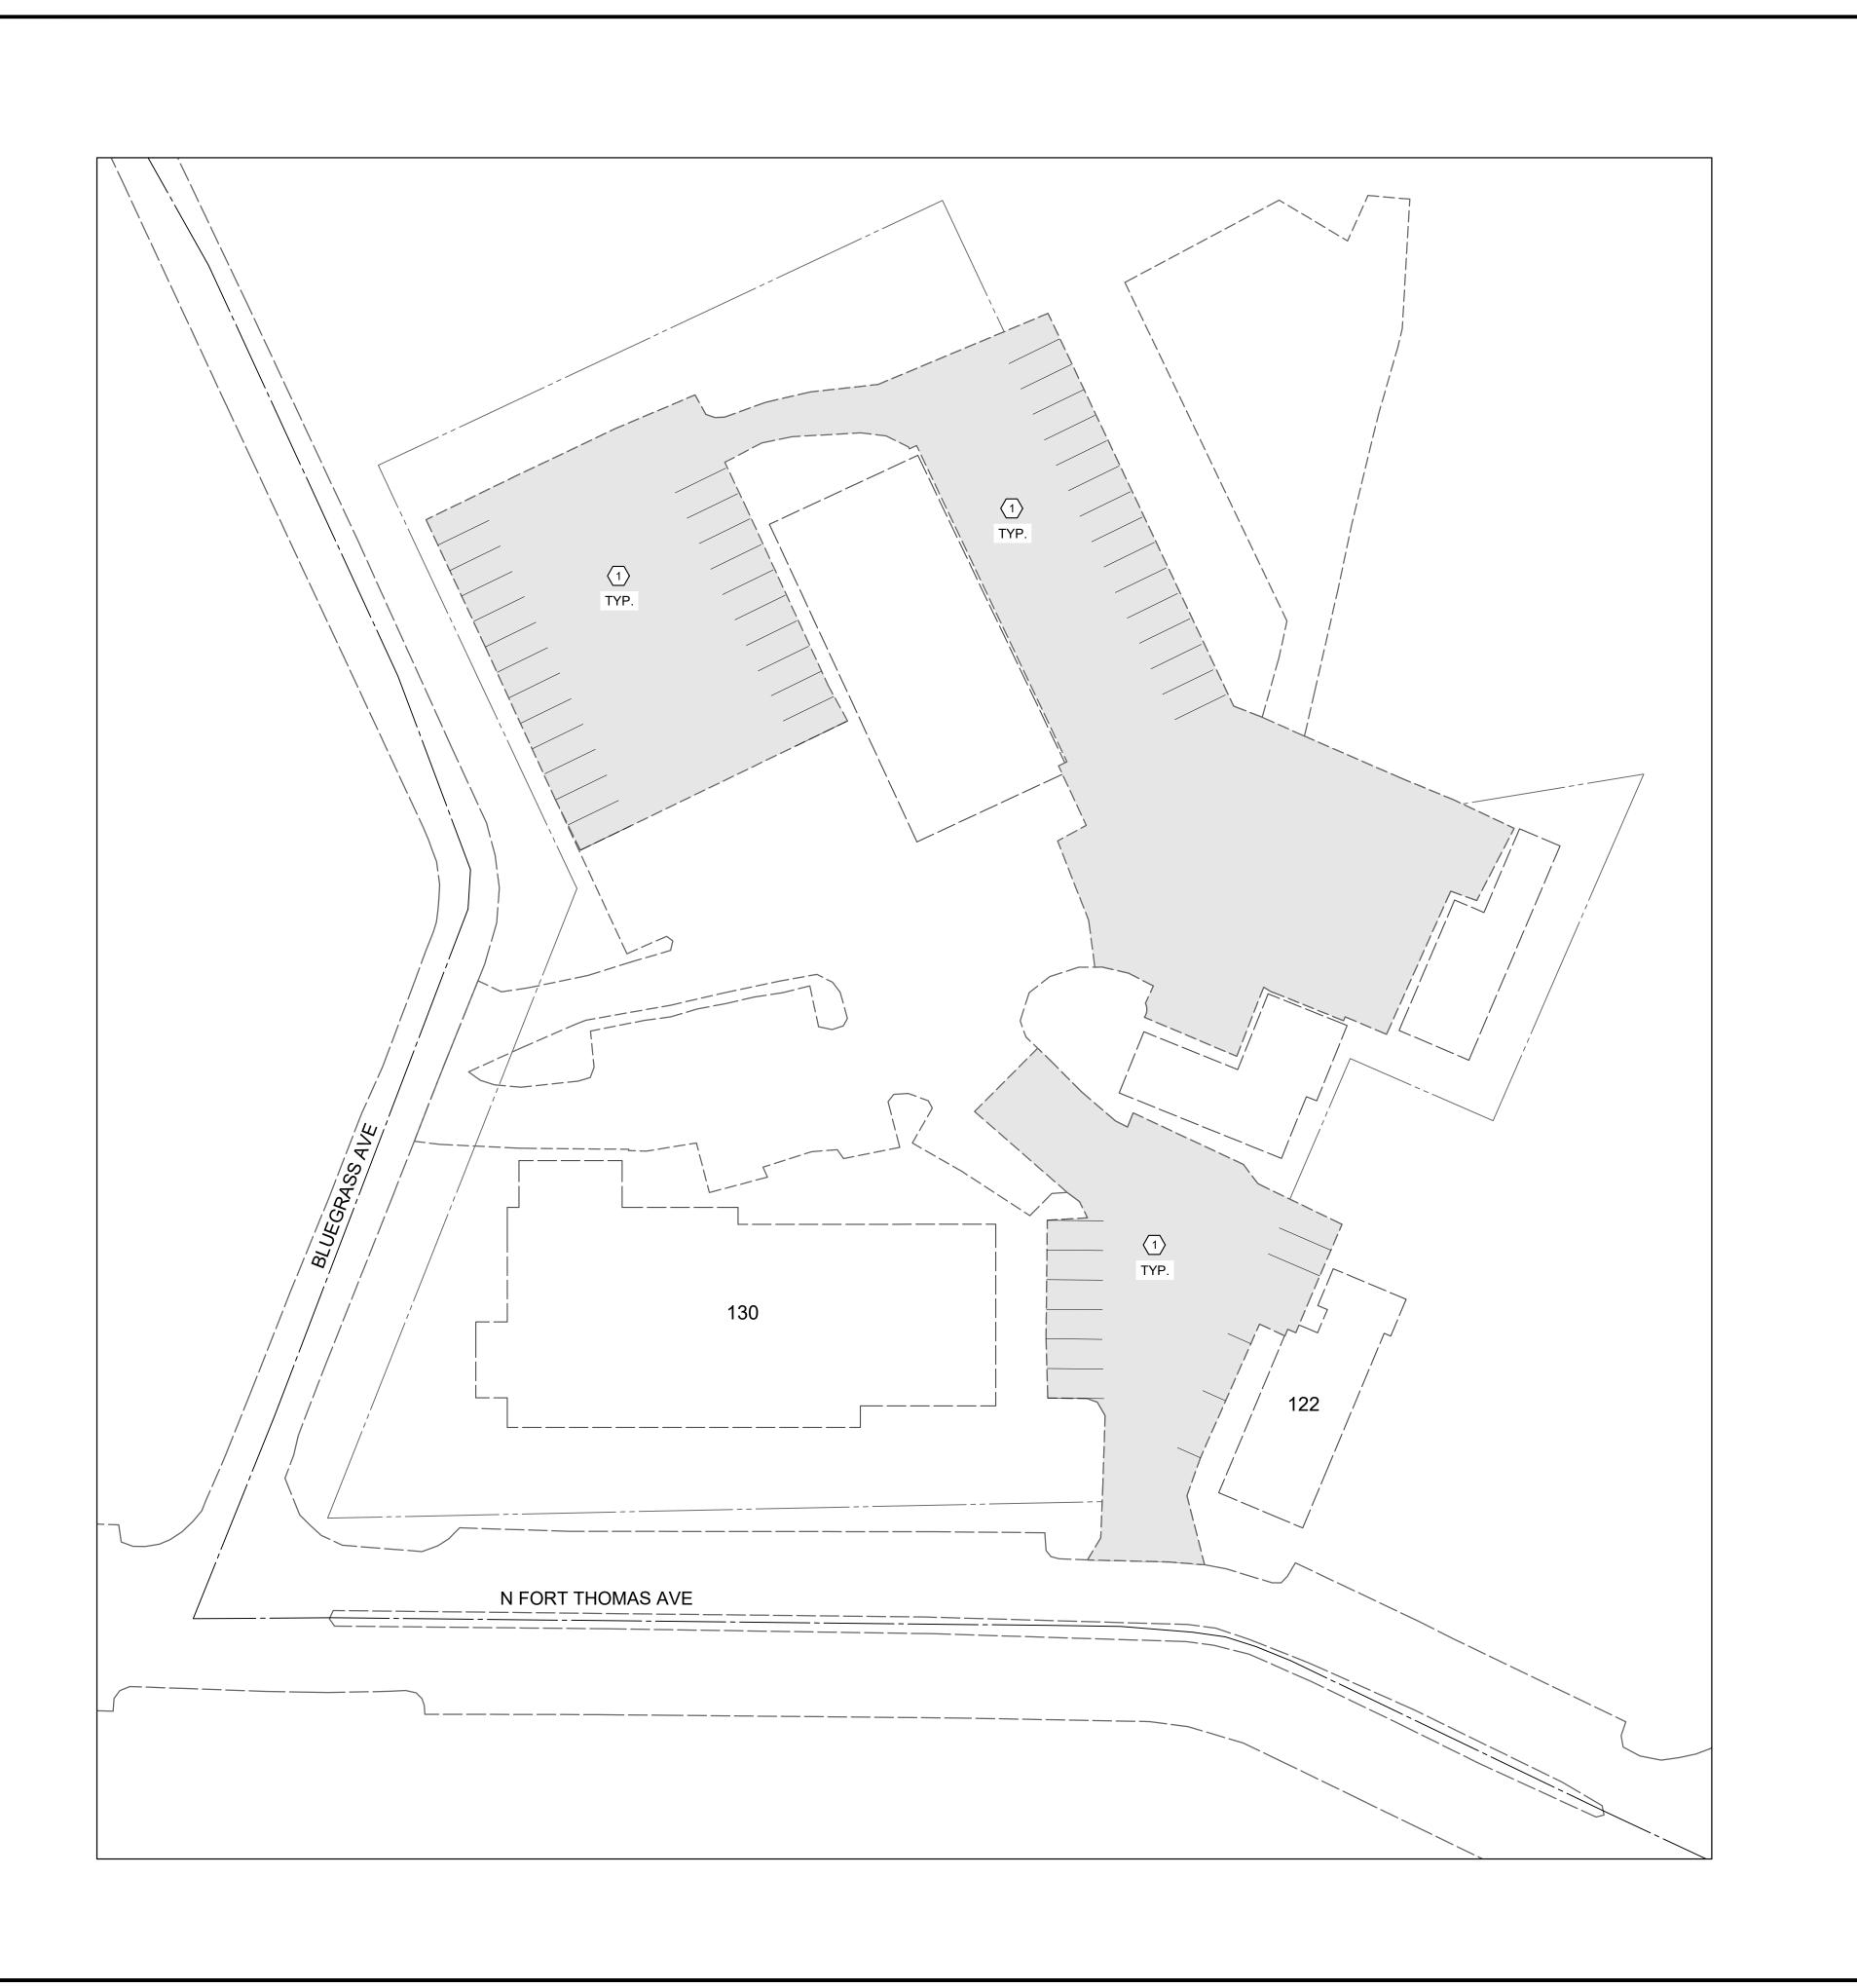

H:\2024\240102\DWG\SHEETS\240102 - BASE SHEETS - WH & PR.DWG - ALT A - 4/9/2024 11:12:54 AM - HOSEA CUNNINGHAM



0' 30' SCALE: 1" = 30

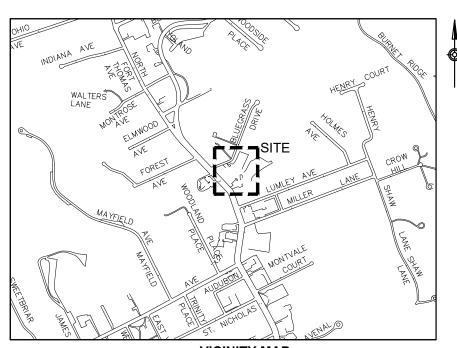

VICINITY MAP


2" ASPHALT MILL AND OVERLAY

#### NOTES

- THE FINAL FULL DEPTH REPAIR AREAS WILL BE MARKED WHEN THE PLANING OPERATIONS HAVE BEEN COMPLETED.
- ADJUSTMENTS TO VALVE BOXES, METERS OR OTHER ASSOCIATED GAS, ELECTRIC, TELEPHONE, WATER, OR CABLE FACILITIES, IF NECESSARY, SHALL BE CONSIDERED INCIDENTAL TO THE CONTRACT AND SHALL BE COMPLETED PER UTILITY OWNER REQUIREMENTS.
- 3. RESTORE ALL DOWNSPOUT LINES IN CURB.
- 4. FINAL PAVEMENT ELEVATION AT CURB LINE SHALL NOT EXCEED THE EXITING ASPHALT ELEVATION AT CURB LINE.

CONSTRUCTION NOTES

1 ITEM 713 - 4" WHITE STRIPE (2 COATS)

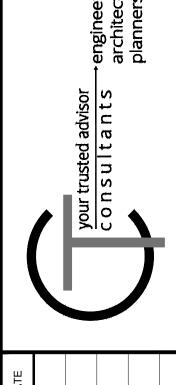

	ISSUE DATE:	0
CITY OF FORT THOMAS	П	
CAMPBELL COUNTY KENTUCKY	j	
	DESIGNED BY:	
ALTERNATE BID A	DRAWN BY:	
I HOMAS CITY BUILDING LOT	CHECKED BY:	

PROJECT NO.


240102

DISCIPLINE

CIVIL

SHEET NAME


ALT A

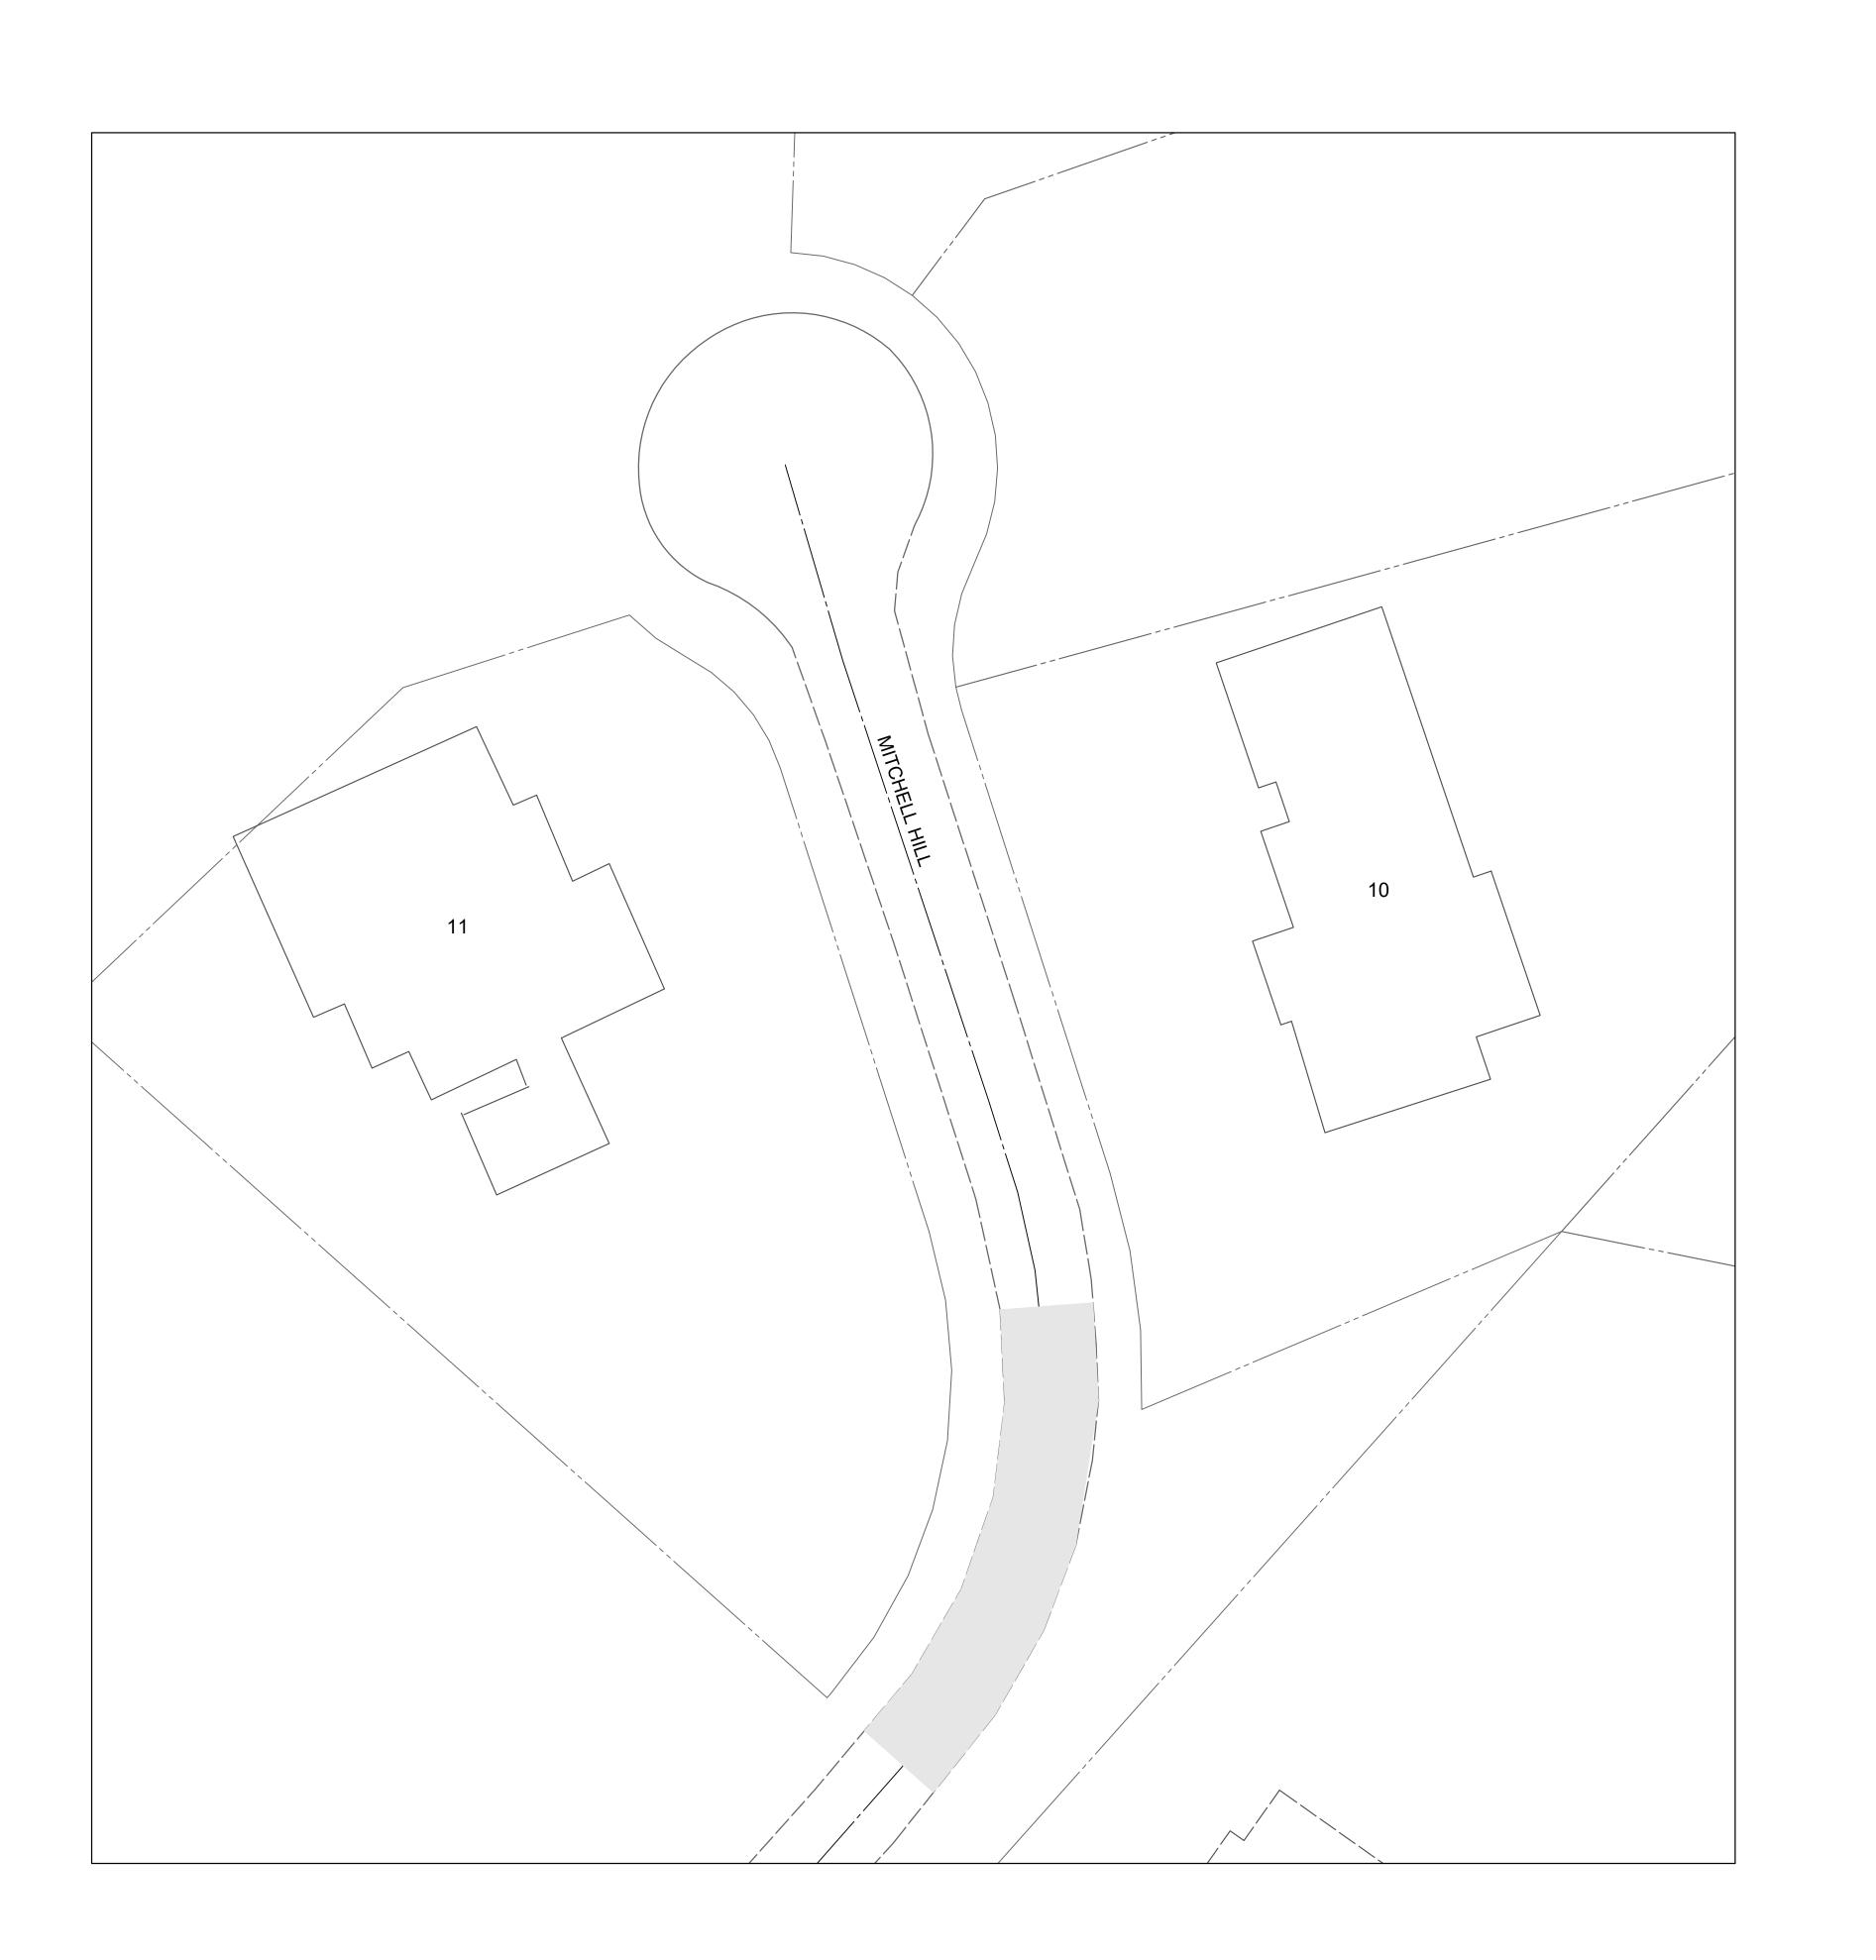

H:\2024\240102\DWG\SHEETS\240102 - BASE SHEETS - WH & PR.DWG - ALT B - 4/9/2024 11:12:54 AM - HOSEA CUNNINGHAM



0' 20' SCALE: 1" = 20

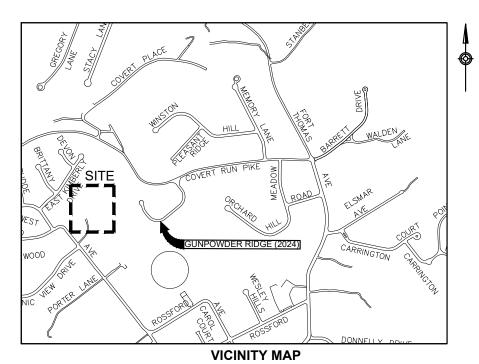

2" ASPHALT MILL AND OVERLAY


#### NOTES

- THE FINAL FULL DEPTH REPAIR AREAS WILL BE MARKED WHEN THE PLANING OPERATIONS HAVE BEEN COMPLETED.
- ADJUSTMENTS TO VALVE BOXES, METERS OR OTHER ASSOCIATED GAS, ELECTRIC, TELEPHONE, WATER, OR CABLE FACILITIES, IF NECESSARY, SHALL BE CONSIDERED INCIDENTAL TO THE CONTRACT AND SHALL BE COMPLETED PER UTILITY OWNER REQUIREMENTS.
- 3. RESTORE ALL DOWNSPOUT LINES IN CURB.
- 4. FINAL PAVEMENT ELEVATION AT CURB LINE SHALL NOT EXCEED THE EXITING ASPHALT ELEVATION AT CURB LINE.

		→erigineers architects	planners
<b>∠</b>	your trusted advisor	consultants	<b>\</b>
	_		


04/11/2024	1" = 40'	HCUN	HCUN	RSEI
ISSUE DATE: 0	SCALE:	DESIGNED BY:	DRAWN BY:	СНЕСКЕВ ВҮ:
5				<b>5</b>

	ISSUE	SCALE	DESIG		DRAW	,	CHEC
	RESURFACING PROGRAM	CITY OF FORT THOMAS	CAMPBELL COON 17, NEW LOCKY		ALIEKNAIE BID B	MITCHELL HILL RESURFACING	
		PROJE <b>240</b>			2		$\dashv$
_					_		$\dashv$
CIVIL							
SHEET NAME							
	ALT B						
	SHEET	Т			OF		

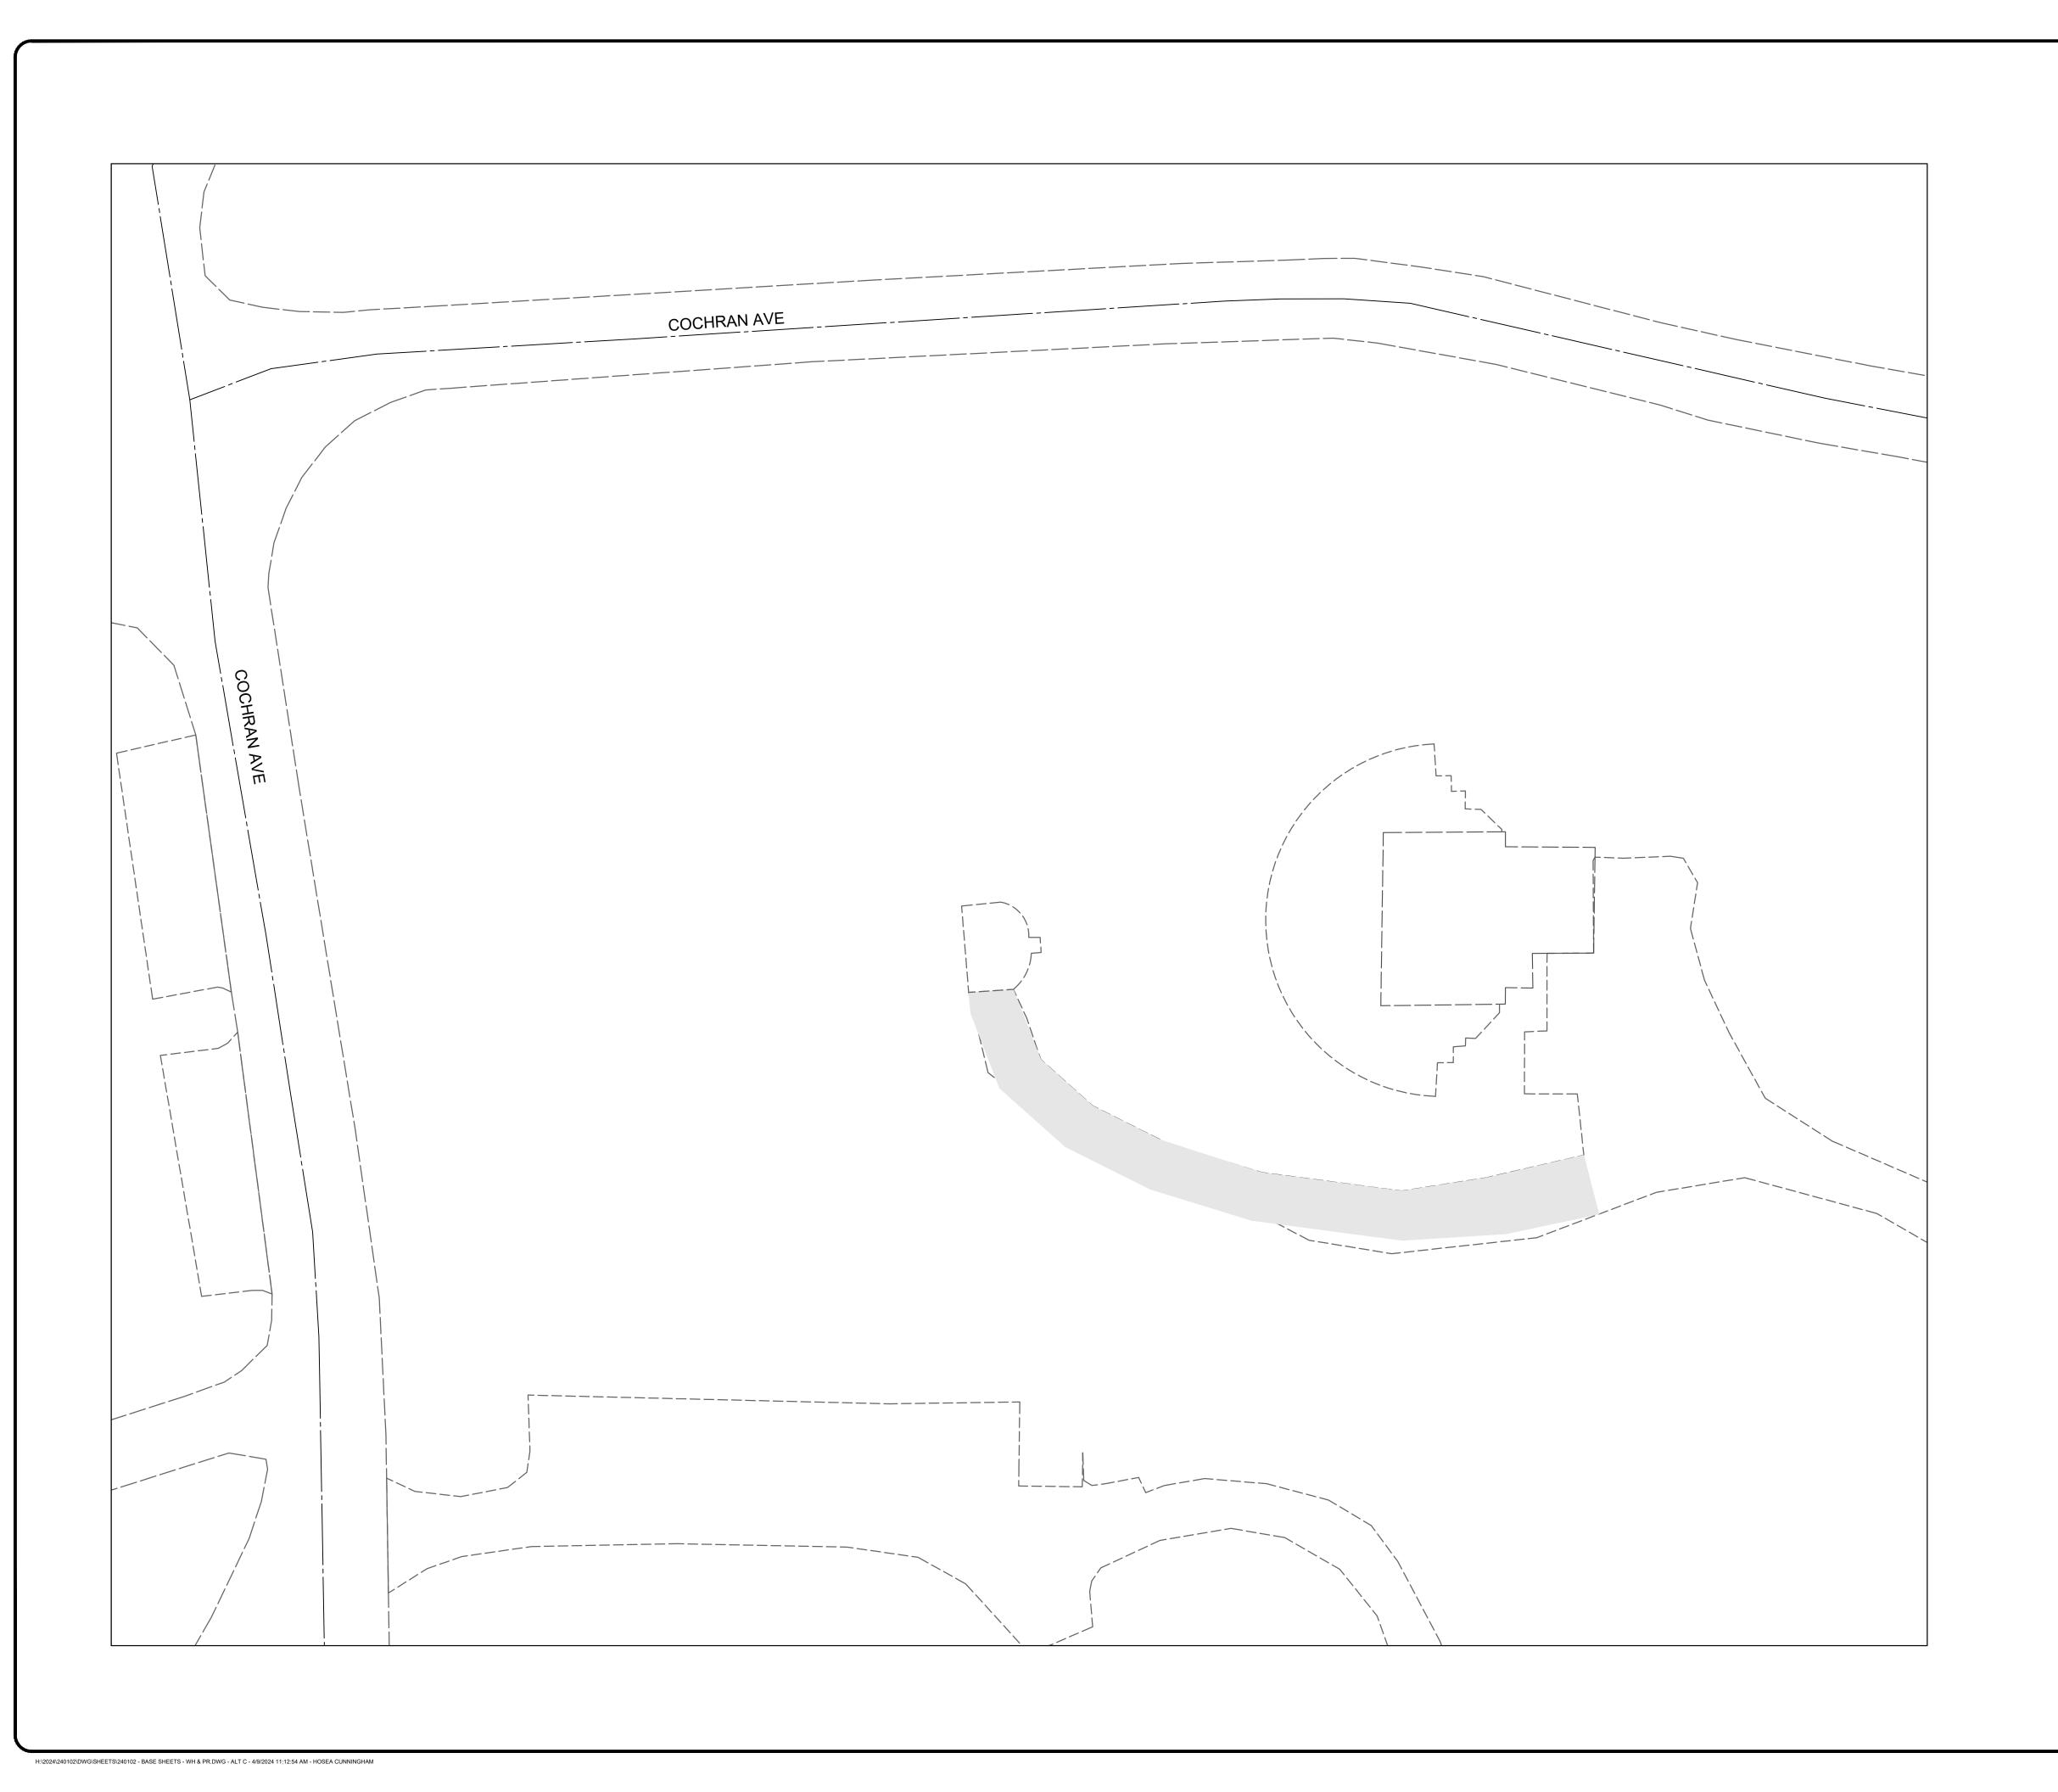



0' 20' SCALE: 1" = 20

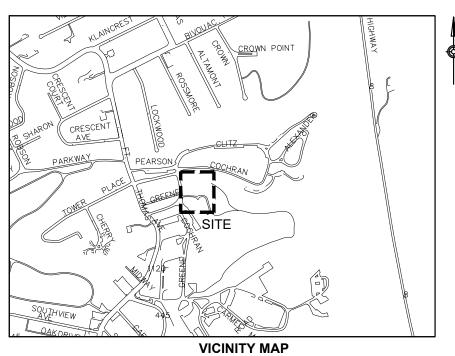

# HATCH LEGEND

CUT 11.5" (BY OTHERS) REPLACE WITH 6" STONE (BY OTHERS) 4" BASE COURSE 1.5" SURFACE COURSE

#### NOTES

- THE FINAL FULL DEPTH REPAIR AREAS WILL BE MARKED WHEN THE PLANING OPERATIONS HAVE BEEN COMPLETED.
- ADJUSTMENTS TO VALVE BOXES, METERS OR OTHER ASSOCIATED GAS, ELECTRIC, TELEPHONE, WATER, OR CABLE FACILITIES, IF NECESSARY, SHALL BE CONSIDERED INCIDENTAL TO THE CONTRACT AND SHALL BE COMPLETED PER UTILITY OWNER REQUIREMENTS.
- 3. RESTORE ALL DOWNSPOUT LINES IN CURB.
- 4. FINAL PAVEMENT ELEVATION AT CURB LINE SHALL NOT EXCEED THE EXITING ASPHALT ELEVATION AT CURB LINE.

→enginee architec planner	
your trusted advisor	
	•

GRAM	AS		ָ ֖֖֖֖֖֖֖֖֖֖֖֖֖֖֖֖֖֖֖֖֖֖֖֖֖֖֖֖֖֖֖֖֖֖֖֖֓֞	-K PAIH
ISSUE DATE:	SCALE:	DESIGNED BY:	DRAWN BY:	СНЕСКЕD ВУ:
04/11/2024	1" = 40'	HCUN	HCUN	RSEI

RESURFACING PROGRAM	CITY OF FORT THOMAS	CAMPBELL COUNTY, KENTUCKY	ALTERNATE BID C	<b>TOWER PARK THEATER PATH</b>
PROJECT NO.				
240102				
DISCIPLINE				
SHEET NAME				