## AKETRAN

### FUEL TANK UPGRADE

# 555 LAKESHORE BOULEVARD PAINESVILLE TOWNSHIP, LAKE COUNTY, OHIO

**MAY**, 2024

### **ADMINISTRATION:**

BEN CAPELLE . . . . . . . . CHIEF EXECUTIVE OFFICER

ANDREA AABY . . . . . DIRECTOR OF COMPLIANCE ANDDEV.

KEITH BARE..... DIR. OF MAINTENANCE

SHEILA BARE..... HUMAN RESOURCE GENERALIST

NICK BORELLI. . . . . . . . . ASST. DIR. VEHICLE MAINT.

LISA COLLING..... DIRECTOR OF FINANCE
JORDAN GARDNER.... COMMUNICATIONS SPC.

EMILY GILLIAM...... DIRECTOR OF HUMAN RESOURCES

MATT MAIER . . . . . . . DIRECTOR OF OPERATIONS MARC McLAIN . . . . . . . . ASST. DIR. FACILITY MAINT.

TONY MELARAGNO. . . . . DIR. OF INFORMATION TECH.

JULIA SCHICK . . . . . . DIR. OF COMMUNICATIONS

TAMMY SKAGGS..... ASST. DIR. OPERATIONS

KATIE TOTH..... CUSTOMER RELATIONS SUPERVISOR

TRUDY VILCHECK..... ADMINISTRATIVE COORDINATOR

DALE WIECHELMAN..... CUSTOMER OUTREACH SPECIALIST

### **LAKETRAN BOARD OF TRUSTEES:**

BRIAN J. FALKOWSKI ...... PRESIDENT

CHUCK ZIBBEL, PE. ..... VICE-PRESIDENT

DONNA P McNAMEE ..... OPERATIONS CHAIR

GARY SWANSON .... SPECIAL PROJECTS CHAIR


WILLIAM F. EPPICH
DANIELLA NUNNALLY
MICHAEL PIZMOHT
LANE H. SHEETS
KIM STENGER



1-800-362-2764

CALL TWO WORKING DAYS BEFORE YOU DIG (NON MEMBERS MUST BE CALLED DIRECTLY)

- THE SURVEY SHOWN ON THESE PLANS WAS OBSERVED IN THE FIELD FOR CONSTRUCTION PURPOSES ONLY AND MAY NOT BE SUITABLE FOR PROPERTY LINE SURVEYS OR ANY OTHER PURPOSE.
- . UNDERGROUND BUILDING SERVICE UTILITY LINES ARE NOT SHOWN ON THE PLANS. THE CONTRACTOR SHALL BE
- 3. THE CONTRACTOR IS RESPONSIBLE TO CALL OHIO UTILITIES PROTECTION SERVICE @ 1-800-362-2764, THREE WORKING

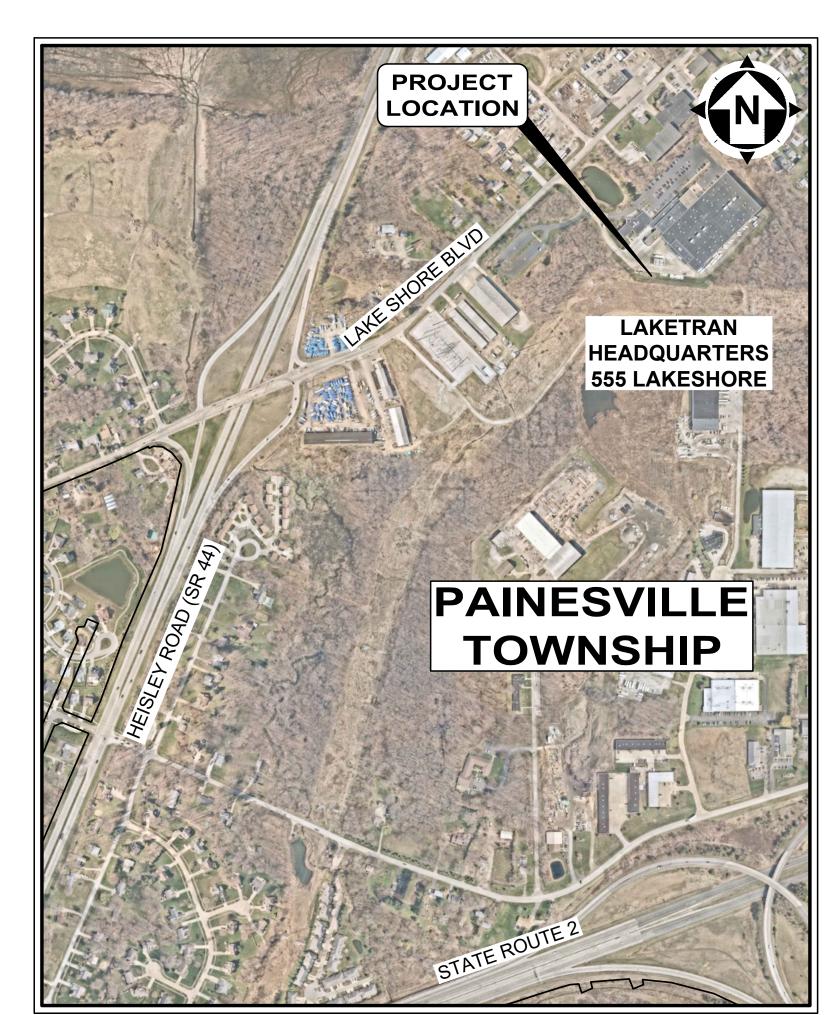

SITE LOCATION MAP

## your trusted advisor c o n s u | t a n t s architects planners

### **INDEX OF SHEETS**

- 1 ..... COVER SHEET
- 2 ..... GENERAL NOTES
- 3 ..... EXISTING CONDITIONS PLAN
- 4 ..... SITE PLAN
- 5 ..... ELECTRIC CONDUIT LAYOUT PLAN
- 6 ..... ELECTRIC DETAILS & SPECIFICATIONS
- 7-8 ..... TANK DETAILS
- 9 ..... STANDARD DETAILS





### <u>GENERAL</u>

- 1. THE CONTRACTOR SHALL PERFORM ALL OF THE WORK AND FURNISH ALL OF THE LABOR AND MATERIALS NECESSARY FOR THE FINAL COMPLETION OF THIS CONTRACT IN THE MANNER AND UNDER THE CONDITIONS HEREIN SPECIFIED AND PROVIDED AND IN ACCORDANCE WITH THE CONTRACT DRAWINGS.
- 2. A PRE-CONSTRUCTION MEETING SHALL BE SCHEDULED BY THE OWNER PRIOR TO THE COMMENCEMENT OF ANY WORK. IN ADDITION, THE CONTRACTOR SHALL PROVIDE 48-HOUR NOTICE TO THE OWNER, AND THE ENGINEER PRIOR TO COMMENCEMENT OF
- 3. ACCESS TO ALL DRIVEWAYS WILL BE MAINTAINED AT ALL TIMES EXCEPT WHEN PAVEMENT REPLACEMENT WILL NOT PERMIT; WORK SHALL BE STAGGERED, SO AS TO KEEP ONE ACCESS ALWAYS FUNCTIONING.
- 4. THE CONTRACTOR SHALL BE RESPONSIBLE FOR SECURING A SITE FOR DISPOSAL OF ALL EXCAVATED MATERIAL THAT IS UNSUITABLE FOR USE AS BACKFILL AND ALL OTHER EXCESS EXCAVATED MATERIALS. THE CONTRACTOR SHALL PROVIDE THE OWNER WITH THE LOCATION OF THE DISPOSAL SITE AND WRITTEN PERMISSION FOR USE OF THE SITE FROM THE RESPECTIVE PROPERTY OWNER.
- 5. ALL OVER-THE-ROAD VEHICLES USED ON THE PROJECT BY ALL CONTRACTORS AND SUBCONTRACTORS SHALL BE CLEARLY MARKED SHOWING ITS COMPANY SYMBOL.
- 6. BEFORE THE OWNER WILL APPROVE AND ACCEPT THE WORK AND RELEASE THE GUARANTY RETAINER, THE CONTRACTOR WILL FURNISH THE OWNER A WRITTEN REPORT INDICATING THE RESOLUTION OF ANY AND ALL PROPERTY DAMAGE CLAIMS FILED WITH THE CONTRACTOR BY ANY PARTY DURING THE CONSTRUCTION PERIOD. THE INFORMATION TO BE SUPPLIED SHALL INCLUDE, BUT NOT BE LIMITED TO: NAME OF CLAIMANT, DATE FILED WITH CONTRACTOR, NAME OF INSURANCE COMPANY AND/OR ADJUSTOR HANDLING THE CLAIM, HOW THE CLAIM WAS RESOLVED AND IF CLAIM WAS NOT RESOLVED FOR THE FULL AMOUNT, A STATEMENT INDICATING THE REASON FOR SUCH ACTION.
- 7. ALL SHOP DRAWINGS WILL BE SUBMITTED TO THE ENGINEER FOR REVIEW.

### PROJECT SPECIFICATIONS

ALL WORK REQUIRED TO COMPLETE THIS IMPROVEMENT SHALL BE PERFORMED IN STRICT ACCORDANCE WITH THE DETAILED PLANS AND SPECIFICATIONS AND THE CURRENT OHIO DEPARTMENT OF TRANSPORTATION'S STANDARD CONSTRUCTION DRAWINGS (SCDs). STANDARDS AND SPECIFICATIONS. IN THE EVENT OF A CONFLICT BETWEEN THE SPECIFICATION/REQUREMENTS, THE MORE STRINGENT OF THE TWO WILL GOVERN, AS DETERMINED BY THE ENGINEER.

### PROJECT SAFETY

THE CONTRACTOR SHALL MAINTAIN A SAFE WORKING ENVIRONMENT AT THE PROJECT SITE AT ALL TIMES. THE CONTRACTOR SHALL PROPERLY SUPPORT AND/OR MAINTAIN ALL EXCAVATIONS PER APPLICABLE SAFETY REQUIREMENTS AND COMPLY WITH ALL OSHA REGULATIONS. ADEQUATE BARRICADES, WARNING LIGHTS, SIGNS, FENCING, ETC., SHALL BE ERECTED AROUND THE CONSTRUCTION AREA DURING ALL NON-WORKING HOURS TO ALERT PERSONS TO THE POTENTIAL DANGER ASSOCIATED WITH THE AREA UNDER CONSTRUCTION AS WELL AS TO PREVENT ACCESS TO UNAUTHORIZED PERSONNEL TO THE CONSTRUCTION SITE. IT SHALL BE THE CONTRACTOR'S RESPONSIBILITY TO ENSURE THE SAFETY OF THE GENERAL PUBLIC AS WELL AS ALL CONSTRUCTION PERSONNEL. PUBLIC STREETS, AS WELL AS ADJACENT PARKING AREAS, SHALL BE KEPT CLEAN AND FREE OF DEBRIS (i.e. MUD, STONE, ETC.) AT ALL TIMES. THE CONTRACTOR SHALL CONTACT ALL LOCAL EMERGENCY AGENCIES TO THE NATURE OF THE PROPOSED PROJECT PRIOR TO BEGINNING ANY CONSTRUCTION ACTIVITY. ACCESS FOR EMERGENCY VEHICLES SHALL BE MAINTAINED AT ALL TIMES.

### UTILITY NOTIFICATION

AT LEAST TWO WORKING DAYS PRIOR TO COMMENCING OPERATIONS ON THIS PROJECT, THE CONTRACTOR SHALL NOTIFY THE ENGINEER, THE REGISTERED UTILITY PROTECTION AGENCY/SERVICE, AND THE OWNERS OF ANY OTHER UTILITIES (PUBLIC AND/OR PRIVATE) THAT MAY HAVE UTILITY LINES OR FACILITIES WITHIN THE VICINITY OF THIS PROJECT, CONTACT THE OHIO UTILITY PROTECTION SERVICE (OUPS) AT 1-800-362-2764.

### PROTECTION OF UTILITIES

THE CONTRACTOR SHALL TAKE ALL PRECAUTIONS NECESSARY TO LOCATE, ISOLATE, PROTECT AND SUPPORT ANY EXISTING UTILITIES WITHIN OR ADJACENT TO THE PROJECT SITE WHICH MAY BE ENCOUNTERED DURING THE COMPLETION OF THE PROPOSED IMPROVEMENTS. UTILITIES MUST BE KEPT IN SERVICE AT ALL TIMES.

THE LOCATIONS OF THE UNDERGROUND UTILITIES ARE PLOTTED ACCORDING TO THE INFORMATION FURNISHED BY THE UTILITIES CONCERNED AND THE OWNER DOES NOT GUARANTEE THE ACCURACY THEREOF.

IN THE EVENT OF DAMAGE TO EXISTING PUBLIC AND/OR PRIVATE UTILITIES, THE AGENCY CONCERNED SHALL BE NOTIFIED IMMEDIATELY AND ALL REPAIR WORK SHALL BE EXECUTED IN ACCORDANCE WITH THE SPECIFICATIONS OF THE RESPECTIVE AGENCY AT NO ADDITIONAL EXPENSE TO THE PROJECT OR THE OWNER, INCLUSIVE OF INSPECTION FEES, MAINTENANCE CREWS, ETC.

### UTILITY OWNERSHIP

THE FOLLOWING UTILITIES AND OWNERS ARE LOCATED WITHIN THE WORK LIMITS OF THIS PROJECT:

COUNTY ENGINEER'S OFFICE 550 BLACKBROOK ROAD PAINESVILLE, OHIO 44077

PHONE 440-350-2770

DOMINION EAST OHIO 320 SPRINGSIDE DRIVE, STE. 320 AKRON, OHIO 44333 PHONE: 330-664-2409 ATTN: KEVIN BIRT EMAIL: relocation@dominonenergy.com

THE ILLUMINATING COMPANY 6896 MILLER ROAD BRECKSSVILLE, OHIO 44141 PHONE: 440-546-8706 ATTN: JOHN ZASSICK JMZASSICK@FIRSTENERGYCORP.COM

SEWER & WATER LAKE COUNTY DEPARTMENT OF UTILITIES 105 MAIN STREET PAINESVILLE, OHIO 44077 PHONE: 440-350-2645 ATTN: MR. RANDY ROTHLISBERGER

AT&T / OHIO 13630 LORAIN AVE., 2ND FLOOR CLEVELAND, OHIO 44111 PHONE: 216-476-6142 ATTN: JAMES JANIS PJ8191@ATT.COM

### ROADWAY EXCAVATION & PAVEMENT

ALL PAVEMENT REMOVAL AND REPLACEMENT, NEW PAVEMENT AND ASSOCIATED ROADWAY WORK WILL BE IN ACCORDANCE WITH THE STATE OF OHIO DEPARTMENT OF TRANSPORTATION CONSTRUCTION AND MATERIALS SPECIFICATIONS, 2023 EDITION, WITH THE MODIFICATIONS AS SET FORTH IN THESE SPECIFICATIONS.

### MAINTAINING TRAFFIC

THE CONTRACTOR SHALL MAINTAIN TRAFFIC ADJACENT TO THE PROJECT AS DESCRIBED WITHIN THESE SPECIFICATIONS AND IN ACCORDANCE WITH THE REQUIREMENTS OF ODOT 614 MAINTAINING TRAFFIC.

ATTENTION IS CALLED TO THE EXISTING LAKETRAN FACILITY CONTRACTOR SHALL MAINTAIN TWO-WAY TRAFFIC ACCESS TO THE FACILITY AT ALL TIMES.

### RESTORATION OF DISTURBED AREAS

EXISTING DRIVES, BERMS, LAWNS, PAVEMENTS, CURBS, SIDEWALKS, SIGNS, MAILBOXES, OR OTHER APPURTENANCES DISTURBED DURING CONSTRUCTION BUT NOT SPECIFICALLY DESIGNATED FOR REMOVAL/REPLACEMENT SHALL BE RESTORED TO A CONDITION EQUAL TO THAT WHICH EXISTED PRIOR TO CONSTRUCTION AND TO THE COMPLETE SATISFACTION OF LAKETRAN. RESTORATION OF EXISTING ROADWAYS SHALL BE IN ACCORDANCE WITH THE GOVERNING AGENCY HAVING AUTHORITY. THE COST FOR RESTORATION OF THE AFOREMENTIONED SHALL BE SOLELY THE CONTRACTOR'S RESPONSIBILITY. NO PUBLIC ROADWAY SHALL BE DISTURBED WITHOUT PRIOR WRITTEN APPROVAL OF THE VILLAGE OF PAINESVILLE AND RESPECTIVE PERMITS OBTAINED.

### EASEMENTS AND RIGHTS-OF-WAY

THE CONTRACTOR SHALL PERFORM HIS WORK WITHIN THE PROPERTIES, EASEMENTS, WORK LIMITS, AND RIGHTS-OF-WAY PROVIDED AT ALL TIMES. NO MATERIAL IS PERMITTED TO BE STORED ON ADJACENT PROPERTIES UNLESS PRIOR WRITTEN PERMISSION HAS BEEN GRANTED.

### PRESERVATION OF PROPERTY CORNERS AND SURVEY MARKERS

THE CONTRACTOR WILL CAREFULLY PRESERVE BENCH MARKS, PROPERTY CORNERS REFERENCE POINTS, AND STAKES AND IN CASE OF DISTURBANCE, HE SHALL ENGAGE A REGISTERED SURVEYOR TO REPLACE THEM AT NO COST TO THE OWNER OR THE PROJECT AND SHALL BE RESPONSIBLE FOR ANY MISTAKES THAT MAY BE CAUSED BY THEIR LOSS OR DISTURBANCE.

### AIR/NOISE CONTROL

- 1. CONSTRUCTION ACTIVITIES WILL BE LIMITED TO WEEKDAY DAYTIME HOURS AS DESCRIBED FURTHER IN THE "SPECIFIC PROJECT REQUIREMENTS" IN THE SPECIFICATION BOOK, UNLESS OTHERWISE APPROVED IN ADVANCE BY THE OWNER.
- 2. CONSTRUCTION EQUIPMENT SHALL BE PROVIDED WITH INTAKE SILENCERS AND MUFFLERS, AS REQUIRED BY SAFETY STANDARDS. 3. ALL CONSTRUCTION VEHICLES SHOULD BE EQUIPPED WITH PROPER EMISSIONS CONTROL
- EQUIPMENT. 4. PERIODICALLY CHECK EQUIPMENT AND MACHINERY FOR PROPER TUNING TO MINIMIZE EXHAUST EMISSIONS AND DUST.

### PROTECTION AGAINST VANDALISM

IT SHALL BE THE RESPONSIBILITY OF THE CONTRACTOR TO PROVIDE SUFFICIENT SITE SECURITY MEASURES AND/OR PERSONNEL TO PROTECT ALL NEW CONCRETE WORK FROM VANDALISM UNTIL THE CONCRETE IS SUFFICIENTLY CURED AT NO ADDITIONAL COST TO THE PROJECT OR THE OWNER.

### SUBSURFACE CONDITIONS

IT IS THE OBLIGATION AND RESPONSIBILITY OF THE CONTRACTOR TO MAKE HIS OWN INVESTIGATION OF SUBSURFACE CONDITIONS PRIOR TO THE SUBMITTAL OF A BID PROPOSAL TO DETERMINE THE EXISTING CONDITIONS.

### SITE DEMOLITION

GENERAL - ALL SITE DEMOLITION SHALL BE PERFORMED IN ACCORDANCE WITH ODOT ITEM 202. THE CONTRACTOR IS RESPONSIBLE FOR COMPLETELY REMOVING THE EXISTING PAVEMENT, WALKS, ISLANDS AND CURBS AS SHOWN ON THE PLANS AT THE LOCATIONS SHOWN. ALL MATERIALS MUST BE DISPOSED OF IN ACCORDANCE WITH ALL LOCAL, STATE AND FEDERAL REGULATIONS.

SITE GRADING - ALL GRADING SHALL BE PERFORMED IN ACCORDANCE WITH ODOT ITEM 203 - LINEAR GRADING, USING SUITABLE ON-SITE MATERIALS (FREE FROM LARGE DIAMETER AGGREGATE) AND AT THE ELEVATIONS SHOWN ON THE GRADING PLAN.

### NOTIFICATION OF EMERGENCY PROVIDERS

THE CONTRACTOR IS REQUIRED TO CONTACT EMERGENCY SERVICE PROVIDERS BEFORE CONSTRUCTION STARTS TO INFORM THE AGENCIES WHOSE SERVICES SHOULD BE AFFECTED BY CONSTRUCTION ACTIVITIES ASSOCIATED WITH THE LOCAL ROADWAY IMPACTS.

THE NOTIFICATION TO PAINESVILLE TOWNSHIP AND LAKE COUNTY SHOULD INCLUDE:

1. SERVICE DIRECTOR, MR. BILL THOMPSON, (440-352-2661)

2. FIRE CHIEF, ERIK BURCHAK, (440-352-7443 DISPATCH NON-EMERGENCY)

### WORK LIMITS

THE WORK LIMITS SHOWN ON THESE PLANS ARE FOR PHYSICAL CONSTRUCTION ONLY. PROVIDE THE INSTALLATION AND OPERATION OF ALL WORK ZONE TRAFFIC CONTROL AND WORK ZONE TRAFFIC CONTROL DEVICES REQUIRED BY THESE PLANS, SPECIFICATIONS, AND REFERENCES AND PROVISIONS OF ODOT ITEM 614 WHETHER INSIDE OR OUTSIDE THESE WORK LIMITS.

### SAMPLING AND TESTING

THE CONTRACTOR SHALL BE RESPONSIBLE FOR ALL COSTS OF TESTING AND CERTIFICATION OF SAME. ALL CERTIFICATIONS OF TESTS AND/OR GRADATIONS FOR MATERIALS TO BE UTILIZED IN THE WORK AND ALL QUALITY CONTROL TESTING SHALL BE PERFORMED BY AN INDEPENDENT LABORATORY (NOT AFFILIATED WITH, OWNED BY, OR MANAGED BY THE CONTRACTOR). THE LABORATORY SHALL BE ACCREDITED BY THE AASHTO MATERIALS REFERENCE LABORATORY FOR THE TYPE OF TESTING PERFORMED.

TEST CRITERIA: THE FOLLOWING TESTS AT A MINIMUM SHALL BE INCLUDED WITH THE CONTRACTOR'S QUALITY CONTROL PLAN:

- 1. COMPACTION: COMPACTION TESTS OR FIELD DENSITY TESTS SHALL BE TAKEN ON ALL EMBANKMENT, TRENCH BACKFILL, SUBGRADE, AND SUBBASE MATERIAL IN ACCORDANCE WITH ODOT 203. MINIMUM TESTING SHALL BE AS FOLLOWS: EMBANKMENT TESTING SHALL BE AT LEAST ONE (1) TEST/3,000 S.F. OF EACH LIFT, TRENCH BACKFILL TESTING SHALL BE AT LEAST ONE (1) TEST/50 L.F. OF EACH LIFT, SUBGRADE AND/OR SUBBASE SHALL BE AT LEAST ONE (1) TEST/3,000 S.F. OF SLABS OR PAVEMENT. PROCTORS OR RELATIVE DENSITY TESTS SHALL BE PERFORMED AS OFTEN AS NECESSARY FOR THE DIFFERING SOILS OR GRANULAR MATERIALS UTILIZED.
- 2. AGGREGATES: FOR EACH MATERIAL AND/OR DIFFERENT SOURCE, THE LABORATORY SHALL PERFORM SOUNDNESS, GRADATION AND OTHER TESTS FOR ALL PARAMETERS SPECIFIED. AGGREGATES INCORPORATED INTO CONCRETE OR ASPHALT MIXES SHALL ALSO BE TESTED FOR MOISTURE CONTENT ON A DAILY BASIS.
- 3. CONCRETE: TEMPERATURE AND UNIT WEIGHT SHALL BE RUN ON FRESH CONCRETE AT INTERVALS SUFFICIENT FOR THE TYPE OF STRUCTURE BEING PLACED AT A MINIMUM OF ONCE PER DAY. SLUMP AND AIR CONTENT TESTS SHALL BE TAKEN A MINIMUM OF ONE TEST PER 20 C.Y., OR AT LEAST ONCE PER DAY. ALL FIELD AND LABORATORY TESTING SHALL BE PERFORMED BY TECHNICIANS CERTIFIED BY THE AMERICAN CONCRETE INSTITUTE (ACI) FOR THE TYPE OF TESTING PERFORMED.
- 4. ASPHALT MIX DESIGN: FOR EACH TYPE OF ASPHALT MIX, SUBMIT JOB MIX FORMULA (JMF) PREPARED BY AN ODOT PRE-QUALIFIED LABORATORY FROM TESTS PERFORMED ON THE AGGREGATES PROPOSED FOR USE. SAMPLE AND TEST FOR GRADATION AND BITUMEN CONTENT AS PER ODOT 441.

### GRASS RESTORATION

- RESTORATION OF TREELAWNS AND DEDICATED GREENSPACE AREAS SHALL BE PERFORMED BY A LANDSCAPE CONTRACTOR TO BE APPROVED BY THE OWNER. THE LANDSCAPE CONTRACTOR MUST BE EXPERIENCED IN COMMERCIAL INSTALLATIONS AND PROVIDE REFERENCES AND OTHER DETAILED INFORMATION TO ENABLE THE OWNER TO JUDGE HIS EXPERIENCE AND CAPABILITY TO PERFORM THE WORK.
- 2. GRASS AREAS TO BE RESTORED OR OTHERWISE CONSTRUCTED SHALL BE
- 3. HYDRO-SEEDING SHALL BE PERFORMED IN ACCORDANCE WITH SECTION 02901 OF THE DETAILED SPECIFICATIONS. RESTORATION SHALL INCLUDE 4" TOPSOIL AND HANDRAKING.

### **RESTORATION**

- 1. THE CONTRACTOR SHALL CLEAN UP ALL DEBRIS AND MATERIALS RESULTING FROM HIS OPERATION AND RESTORE ALL SURFACES, STRUCTURES, DITCHES, AND PROPERTY TO ITS ORIGINAL CONDITION TO THE SATISFACTION OF THE ENGINEER. ANY DITCHES DISTURBED DURING CONSTRUCTION SHALL BE RE-GRADED BY THE END OF THE SAME WORKDAY.
- 2. ALL EXISTING STORM AND SANITARY SEWER FACILITIES, INCLUDING TILE, DAMAGED DURING CONSTRUCTION SHALL BE REPAIRED, REPLACED OR RECONNECTED TO THE EXISTING OR PROPOSED SYSTEM AS DIRECTED BY THE ENGINEER AT NO COST TO THE OWNER.

### ENVIRONMENTAL PROTECTION — PROHIBITED CONSTRUCTION ACTIVITIES

- 1. LOCATING STOCKPILE STORAGE AREAS IN ENVIRONMENTALLY SENSITIVE AREAS. 2. INDISCRIMINATE, ARBITRARY OR CAPRICIOUS OPERATION OF EQUIPMENT IN ANY STREAM CORRIDORS, WETLANDS, SURFACE WATERS OR OUTSIDE THE EASEMENT LIMITS.
- 3. PUMPING OF SEDIMENT-LADEN WATER FROM TRENCHES OR OTHER EXCAVATIONS DIRECTLY INTO ANY SURFACE WATERS, STREAM CORRIDORS, WETLANDS OR STORM SEWERS; ALL SUCH WATER WILL BE PROPERLY FILTERED OR SETTLED TO REMOVE SILT PRIOR TO RELEASE.
- 4. DISCHARGING POLLUTANTS SUCH AS CHEMICALS, FUELS, LUBRICANTS, BITUMINOUS MATERIALS, RAW SEWAGE AND OTHER HARMFUL WASTE INTO OR ALONGSIDE OF STREAMS, WETLANDS, SURFACE WATERS, IMPOUNDMENTS OR INTO NATURAL OR MAN-MADE CHANNELS LEADING THERETO
- 5. PERMANENT OR UNSPECIFIED ALTERATION OF THE FLOW LINE OF ANY STREAM. DAMAGING ANY VEGETATION OUTSIDE OF THE CONSTRUCTION AREA.
- 7. DISPOSAL OF TREES, BRUSH AND OTHER DEBRIS IN ANY STREAM CORRIDORS, WETLANDS, SURFACE WATERS OR AT UNDISCLOSED LOCATIONS.
- 8. OPEN-BURNING OF PROJECT DEBRIS WITHOUT A PERMIT.
- 9. STORING CONSTRUCTION EQUIPMENT AND VEHICLES AND/OR STOCKPILING CONSTRUCTION MATERIALS ON PROPERTY, WHETHER PRIVATE OR PUBLIC, NOT PREVIOUSLY SPECIFIED ON THE PLANS BY THE ENGINEER FOR SUCH PURPOSES.
- 10. RUNNING WELL POINT OR PUMP DISCHARGE LINES THROUGH PRIVATE PROPERTY OR PUBLIC PROPERTY AND RIGHTS-OF-WAY WITHOUT THE WRITTEN PERMISSION OF HTE OWNER AND THE CONSENT OF THE ENGINEER.
- 11. OPERATIONS ENTAILING THE USE OF VIBRATORY HAMMERS OR COMPACTORS OUTSIDE THE HOURS OF 8:00 AM AND 4:30 PM OR OUTSIDE THE HOURS ALLOWED FOR CONSTRUCTION BY LOCAL ORDINANCES OR REGULATIONS.
- 12. CLOSING OFF CLEAR ACCESS TO ANY PUBLIC ALLEY, STREET, ROAD, AVENUE OR BOULEVARD WITHOUT THE PRIOR CONSENT OF MUNICIPAL OFFICIALS AND THE ENGINEER, AND CLOSING CLEAR ACCESS:
- 12.1. BY FIRE PROTECTION EQUIPMENT AND EMERGENCY VEHICLES; 12.2. BY THE PUBLIC TO ANY COMMERCIAL OR PROFESSIONAL PLACE OF BUSINESS,
- QUASI-PUBLIC OR PUBLIC ESTABLISHMENT, OR PLACE OF RESIDENCE; 12.3. BY VEHICLES TO DRIVEWAYS WITHOUT THE PROVISION OF ALTERNATIVE MEANS OF BUILDING INGRESS AND EGRESS.

### **EROSION AND DUST CONTROL**

- 1. SEDIMENT CONTROL SHALL BE ACCOMPLISHED BY HYDRO SEEDING AND MULCHING IMMEDIATELY UPON COMPLETION OF EXCAVATION OR FILL AND FINISH GRADING IN ACCORDANCE WITH ODOT ITEM 659 OR AS DIRECTED BY THE
- 2. THE CONTRACTOR SHALL BEGIN THE RESTORATION PROCESS AS SOON AS CONSTRUCTION IS COMPLETED, PERMANENTLY STABILIZING EACH DISTURBED AREA WITH PERENNIAL VEGETATION INSTALLED ACCORDING TO SOIL
- 3. THE CONTRACTOR SHALL REMOVE DAILY ALL MUD, SOIL AND DEBRIS THAT MAY BE TRACKED ONTO EXISTING STREETS OR DRIVES BY HIS EQUIPMENT OR THAT OF SUBCONTRACTORS OR SUPPLIERS.
- 4. ALL MATERIALS TO BE DISPOSED OF OFF-SITE MUST BE DISPOSED OF IN AN ENVIRONMENTALLY SOUND MANNER IN ACCORDANCE WITH LOCAL, STATE AND FEDERAL REGULATIONS. NO EXCESS MATERIALS ARE TO BE DISPOSED OF IN ANY WETLAND, FLOOD PLAIN OR OTHER ENVIRONMENTALLY SENSITIVE AREA.

CONSERVATION SERVICE STANDARDS AND SPECIFICATIONS.

- 5. EROSION CONTROL MEASURES AT THE DISPOSAL SITE MUST BE INSTALLED AND MAINTAINED UNTIL DISPOSAL IS COMPLETE AND THE DISPOSAL SITE IS PERMANENTLY STABILIZED.
- 6. IT SHALL BE THE RESPONSIBILITY OF THE CONTRACTOR TO APPLY WHEN NEEDED OR ORDERED BY THE OWNER WATER OR CALCIUM CHLORIDE PER ODOT 616 FOR THE ALLEVIATION OR PREVENTION OF DUST NUISANCE ORIGINATING FROM HIS CONSTRUCTION ACTIVITIES. SUFFICIENT QUANTITIES OF CALCIUM CHLORIDE SHALL BE STORED ON THE JOB SITE AT ALL TIMES TO BE USED FOR DUST CONTROL. THE COST OF DUST CONTROL SHALL BE INCLUDED IN THE UNIT BID PRICES FOR ALL ITEMS OF THE PROPOSAL
- 7. OTHER EROSION AND SEDIMENT CONTROL PRACTICES SHALL MINIMIZE SEDIMENT LADEN WATER ENTERING ACTIVE STORM DRAIN SYSTEMS, UNLESS THE STORM DRAIN SYSTEM DRAINS TO A SEDIMENT POND. INLET PROTECTION IS MANDATORY WHERE SEDIMENT SETTLING PONDS WILL NOT BE IMPLEMENTED.

### TRENCH EXCAVATION AND BACKFILL

- 1. ALL EXCAVATION SHALL BE CONSIDERED UNCLASSIFIED. NO ADDITIONAL COMPENSATION SHALL BE ALLOWED THE CONTRACTOR FOR ROCK OR SHALE EXCAVATION.
- 2. BACKFILL FOR ALL UNDERGROUND UTILITIES INSTALLED UNDER PAVEMENT, OR WITHIN A 1:1 ZONE OF INFLUENCE PARALLEL OR TRANSVERSE TO PAVEMENT, SHALL BE "COMPACTED GRANULAR BACKFILL" AS DESCRIBED IN SPECIFICATION SECTION 312323.14 AND IN ACCORDANCE WITH THE PLANS. BACKFILL IN OTHER AREAS SHALL BE AS DESCRIBED IN SPECIFICATION SECTION 312323.13 - "COMPACTED BACKFILL" OR SECTION 312323.14 - "COMPACTED GRANULAR BACKFILL". THE OWNER AND THE ENGINEER DO NOT GUARANTEE NOR SUGGEST THE INSITU MATERIAL TO BE EXCAVATED WILL BE SUITABLE OR IN ITS PRESENT STATE WILL CONSIST OF THE PROPER MOISTURE CONTENT TO ACHIEVE THE COMPACTION REQUIREMENTS. THE CONTRACTOR SHALL MAKE HIS OWN DETERMINATION AS TO THE BACKFILL MATERIAL HE WILL USE. UPON REQUEST, THE OWNER WILL PROVIDE ACCESS TO THE SITE FOR THE CONTRACTOR TO CONDUCT SUCH INVESTIGATION AND TESTS DEEMED NECESSARY TO MAKE HIS DETERMINATION. NO EXTRA PAYMENT WILL BE MADE TO DISPOSE OF UNSUITABLE MATERIAL OR FURNISH AND PLACE SUITABLE MATERIAL MEETING THE REQUIREMENTS OF SECTION 312323.13 "COMPACTED BACKFILL" OR SECTION 312323.14 "COMPACTED GRANULAR BACKFILL".
- SLAG PRODUCTS WILL NOT BE PERMITTED FOR BEDDING OR BACKFILL MATERIAL.
- 4. ALL UTILITY LINES CROSSING THE NEW STORM SEWER TRENCH, i.e. STORM LATERALS, SANITARY SEWERS, SANITARY LATERALS, WATER MAINS, WATER SERVICE CONNECTIONS, GAS MAINS, GAS SERVICE CONNECTIONS, UNDERGROUND OBT CONDUITS, CABLE T.V. LINES SHALL BE PROTECTED AND SUPPORTED WITH HARDWOOD PLANKS OR REMOVED AND REPLACED, RECONNECTED AND SUPPORTED ACROSS THE ENTIRE WIDTH OF THE TRENCH. NO ADDITIONAL COMPENSATION WILL BE PAID FOR THE ABOVE WORK, EVEN IF NOT SHOWN ON THE PLANS
- 5. BACKFILL SHALL BE COMPACTED IN LAYERS NOT EXCEEDING 9" IN DEPTH. BACKFILL MATERIAL SHALL BE PLACED WITH 2% OF THE OPTIMUM MOISTURE. THE ENGINEER MAY ORDER THE REMOVAL, REFILLING, RECOMPACTION AND RETESTING OF ALL BACKFILL NOT MEETING THE REQUIREMENTS OF THE CONTRACT.
- 6. BACKFILL MATERIAL SHALL BE PLACED AND COMPACTED USING MACHINE MOUNTED COMPACTION EQUIPMENT IN LAYERS SUFFICIENT TO MEET THE COMPACTION REQUIREMENT ODOT 203.
- 7. NO BACKFILLING OF ANY TRENCHES OR EXCAVATIONS WILL BE PERMITTED WITHOUT TAMPING EQUIPMENT BEING USED. FLOODING, JETTING OR PUDDLING OF BACKFILL WILL NOT BE PERMITTED.

### LINE LEGEND

NOTE: SINGLE LINES ARE USED TO SHOW UTILITIES 12" DIA AND

RIGHT-OF-WAY —	– EX. R/W –––		
PROPERTY LINE -			
PROPOSED SILT FENCE ——	SF -	§	SF
EX. WATER LINE		_	
EX. SANITARY AND M.H.			
EX. STORM AND M.H12" S	STM STM		18" STM
EX. GAS LINE VALVE ————			
(BURIED) TELEPHONE CABLE -		TEL-U	'G
(BURIED) ELECTRIC CONDUIT –		ELEC-	UG
(BURIED) CABLE TV ————	CATV-UG	CA	TV-UG
EDGE OF WATER —— – – –		· <del>-</del>	
EX. UNDERDRAIN	UD -		— UD ——
PR. UNDERDRAIN ————			
PR. CONDUIT FOR FUTURE UTIL		——— UTIL	-FUT

INTE OF PETER J. FORMICA 58646



architects planners

REVISION NO DATE

**LAKETRAN** 

**FUEL TANK UPGRADE** 


LAKE COUNTY, OHIO


ISSUED FOR: BID SET ISSUE DATE: 05-11-24 SCALE: AS SHOWN **DESIGNED BY** PJF DRAWN BY: PJF CHECKED BY:


**GENERAL NOTES** 

232359 DISCIPLINE CIVIL SHEET NAME GN

PROJECT NO.

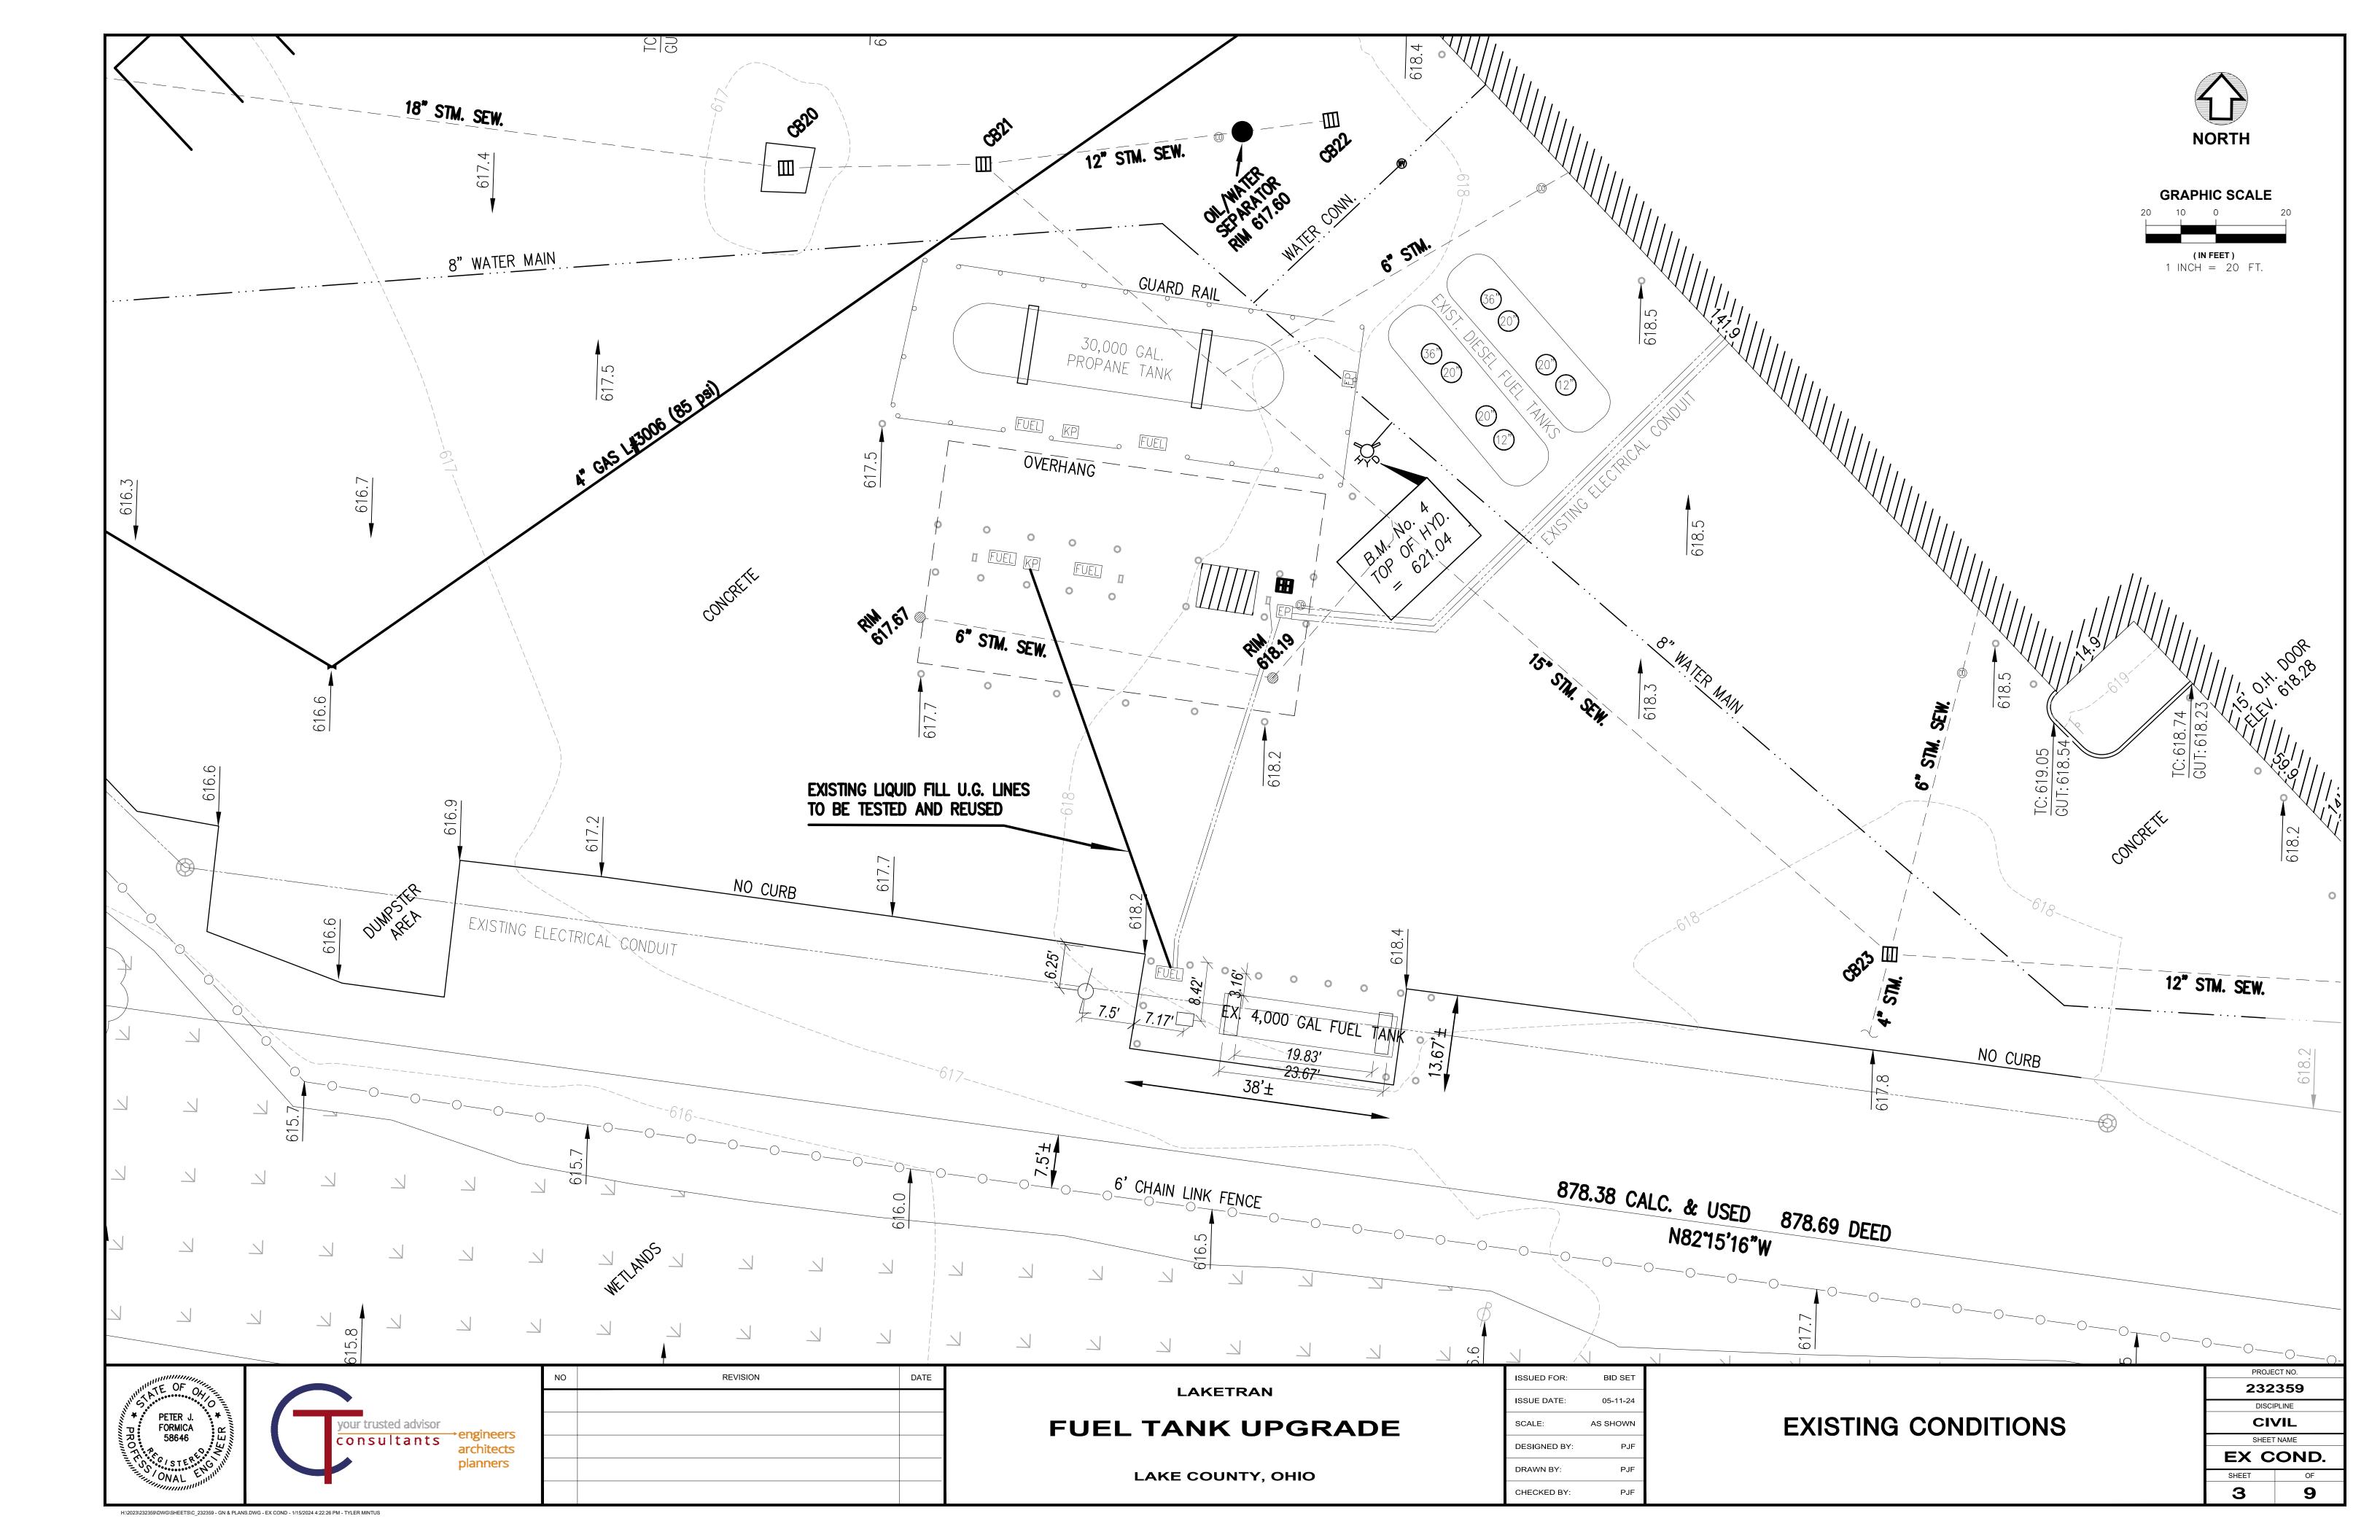

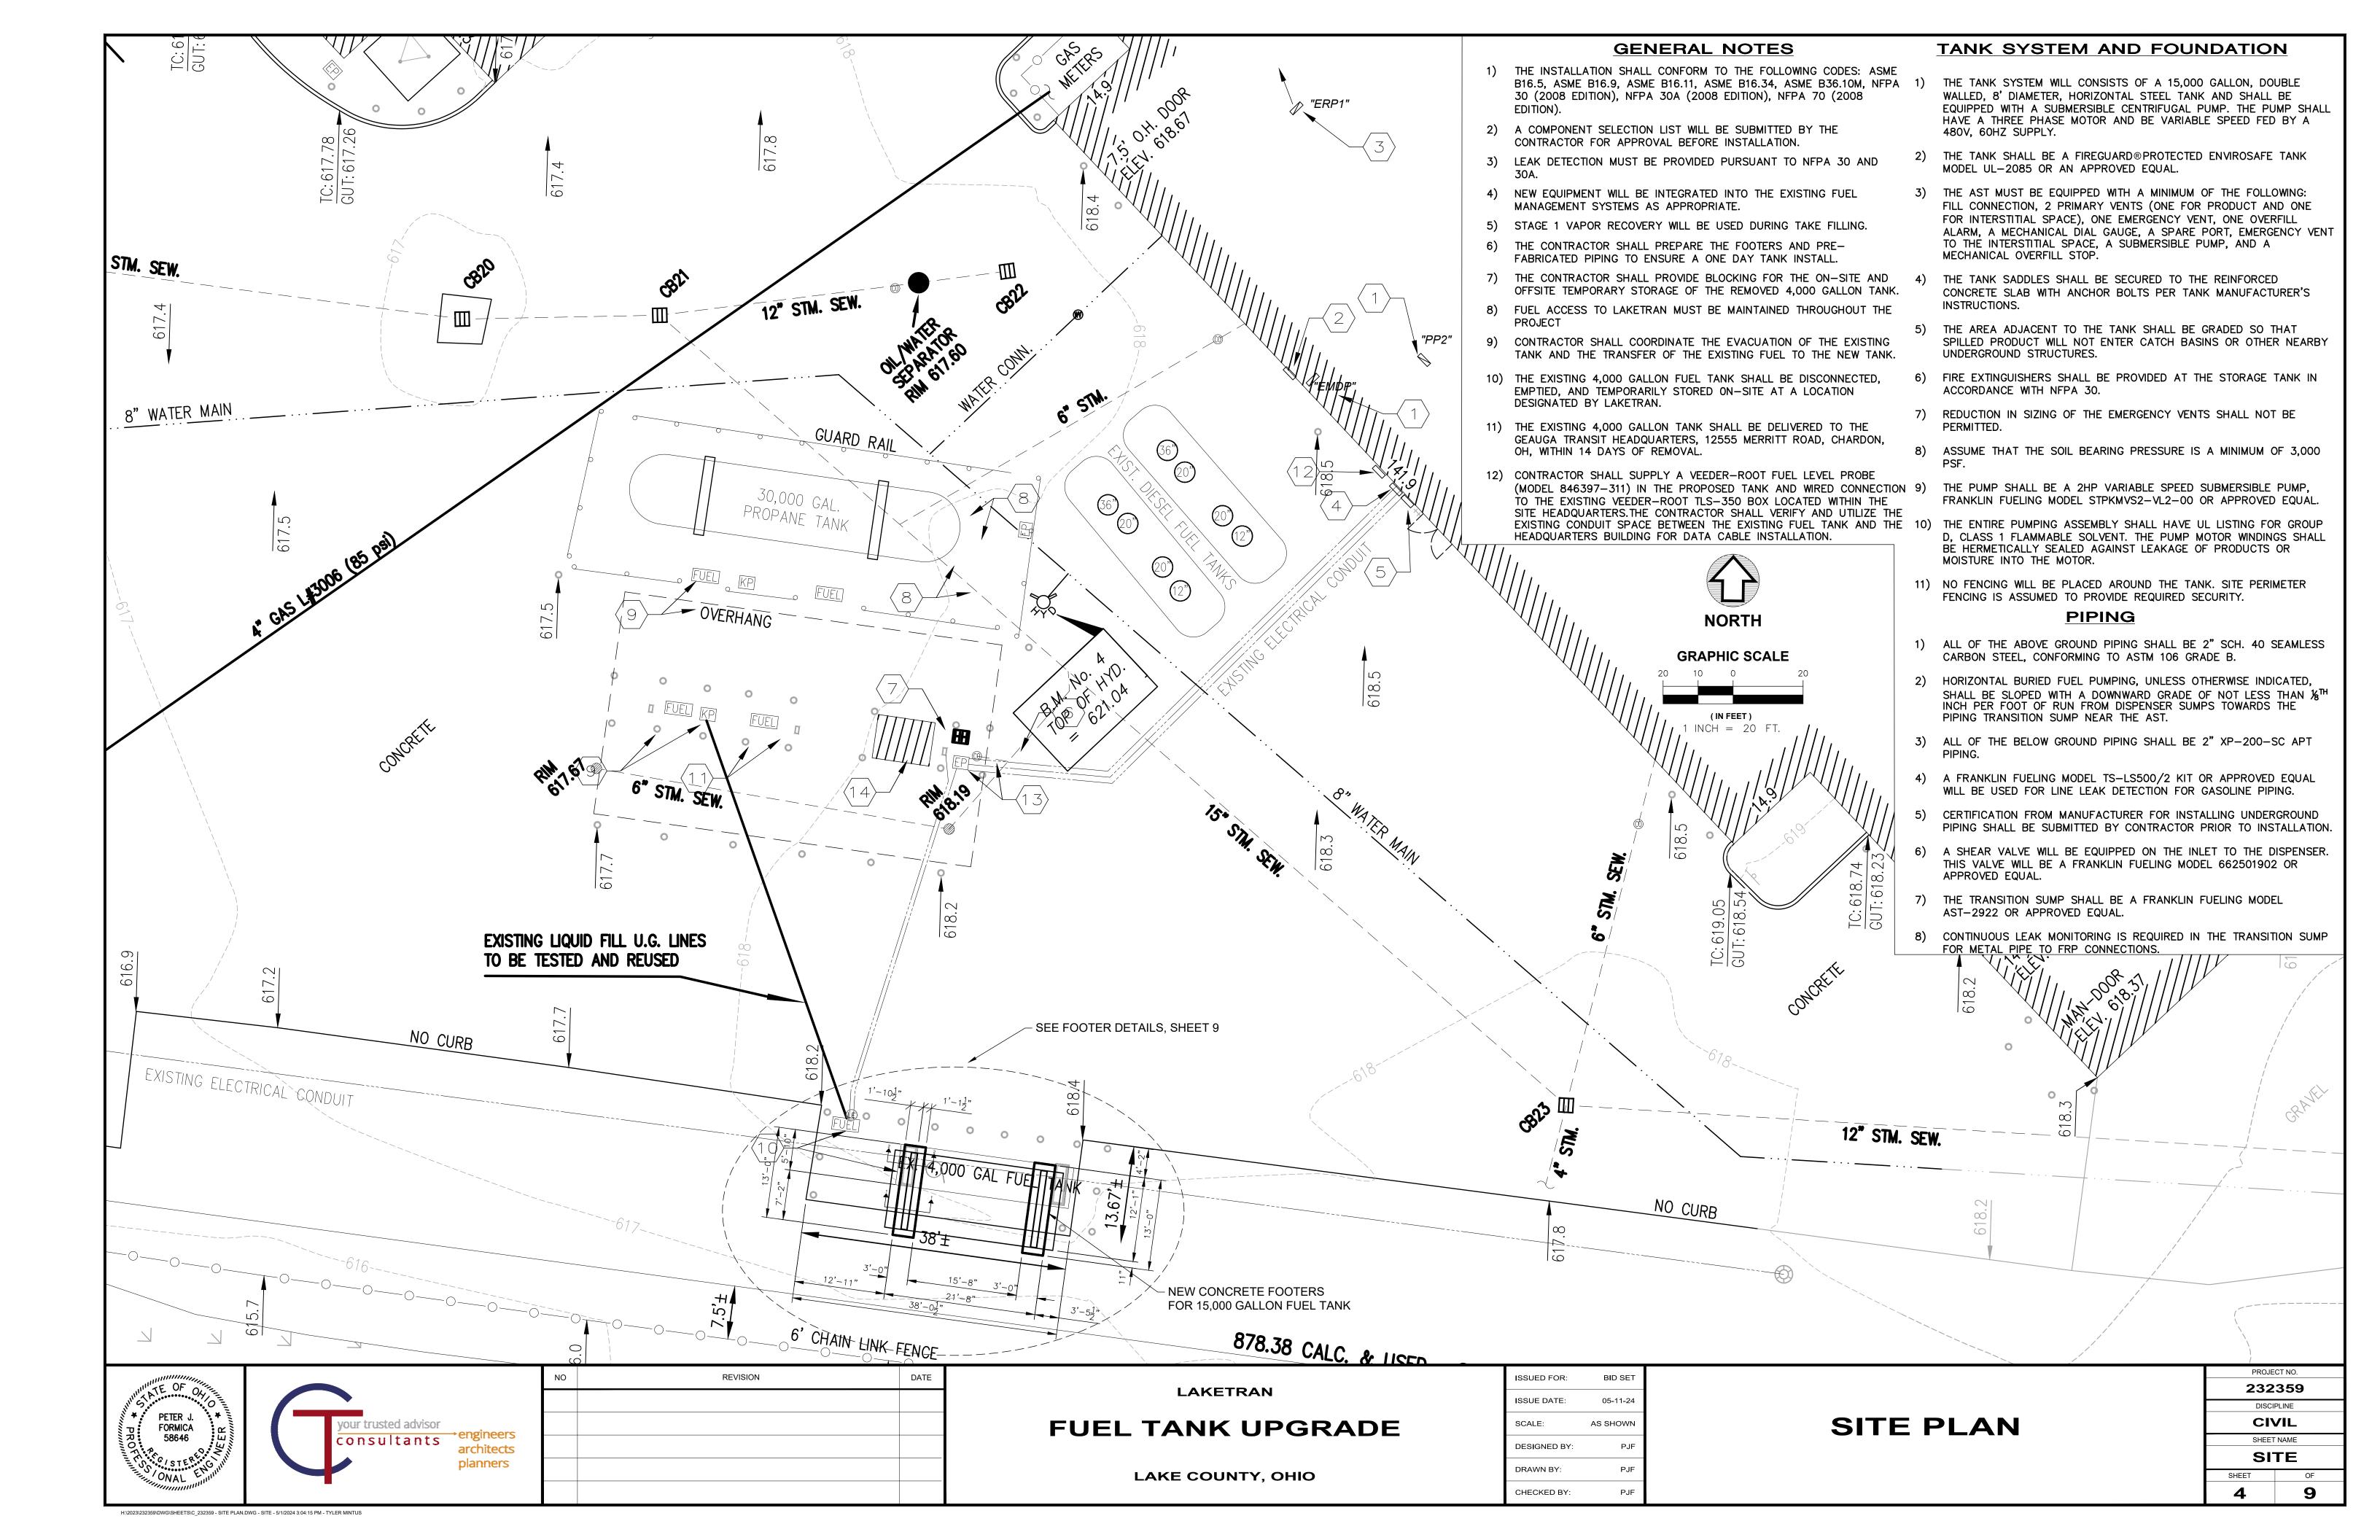

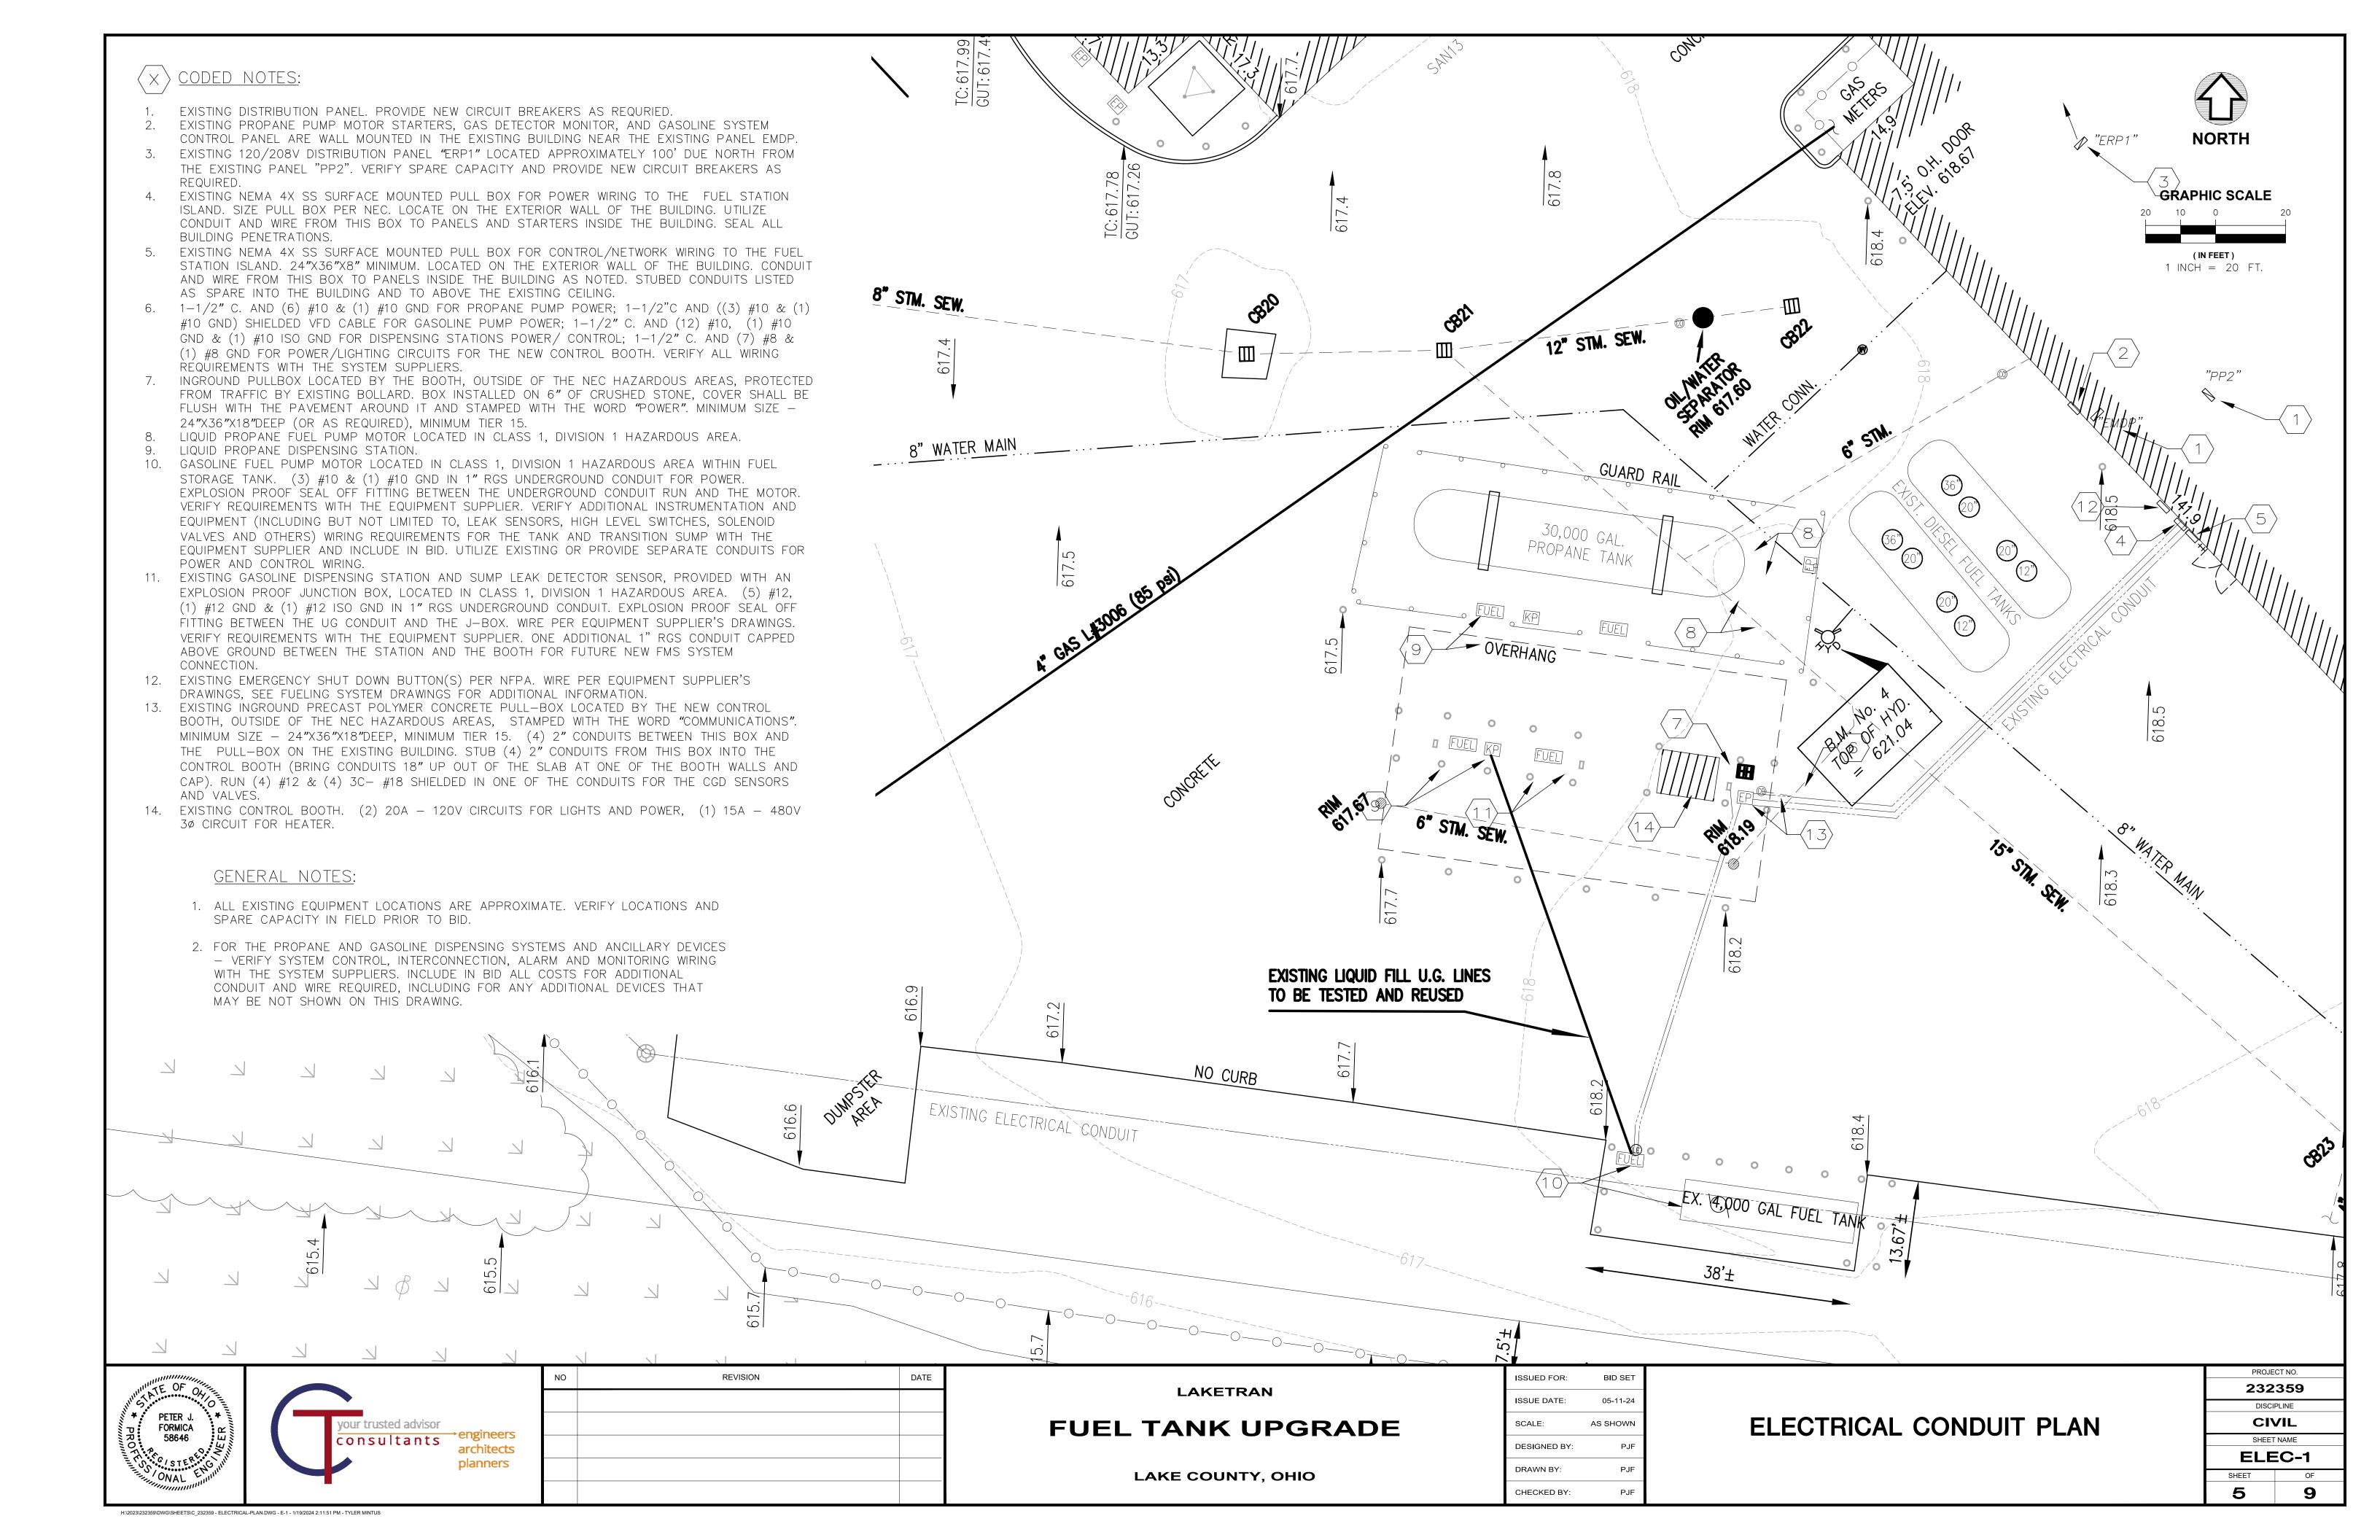

### **ELECTRICAL SPECIFICATIONS**

- 1. THE ELECTRICAL CONTRACTOR SHALL APPLY FOR AND SECURE ALL COSTS AND CHARGES FOR PERMITS, CONSTRUCTION, AND MISCELLANEOUS WORK ASSOCIATED WITH AND REQUIRED FOR THE COMPLETION OF THE PROJECT ELECTRICAL WORK.
- 2. THE ELECTRICAL CONTRACTOR SHALL ARRANGE FOR ALL INSPECTIONS OF ELECTRICAL WORK BY ALL INSPECTION AUTHORITIES HAVING JURISDICTION. COPIES OF INSPECTION REPORTS SHALL BE MADE AVAILABLE TO THE OWNER UPON REQUEST, AND THREE (3) COPIES OF THE APPROVED FINAL INSPECTION REPORT SHALL ACCOMPANY THE REQUEST FOR FINAL PAYMENT.
- 3. ALL WORK SHALL BE IN STRICT ACCORDANCE WITH THE LATEST EDITION OF THE NATIONAL ELECTRICAL CODE, OHIO BUILDING CODE, LOCAL CODES AND ORDINANCES WHERE APPLICABLE, AND REQUIREMENTS OF O.S.H.A.
- 4. ALL MATERIALS AND EQUIPMENT FURNISHED AND INSTALLED BY THE ELECTRICAL CONTRACTOR SHALL BE NEW, U.L. LISTED OR LABELED, AND CONFORM TO NEMA AND ANSI STANDARD WHERE APPLICABLE.
- 5. THE CONTRACTOR SHALL VISIT THE SITE AND FULLY FAMILIARIZE HIMSELF WITH ALL CONDITIONS WHICH AFFECT HIS WORK PRIOR TO BID. COORDINATE AND SCHEDULE WORK WITH OTHER TRADES TO ENSURE SATISFACTORY PERFORMANCE, AVOID DELAYS AND DUPLICATIONS AND MEET THE OWNER'S COMPLETION SCHEDULE FOR THE USE OF THE BUILDING.
- 6. ALL WORK SHALL BE INSTALLED BY WORKMEN FULLY SKILLED IN THE WORK TO BE PERFORMED. REPAIR OR REPLACE EXISTING EQUIPMENT OR PROPERTY OF THE OWNER DAMAGED BY ELECTRICAL TRADES WORKMEN.
- 7. THE ELECTRICAL CONTRACTOR SHALL GUARANTEE MATERIALS AND WORKMANSHIP PROVIDED BY HIM FOR A PERIOD OF ONE (1)
  YEAR FROM THE DATE OF OWNER'S FINAL ACCEPTANCE. REPAIR OR REPLACE ANY DEFECTIVE MATERIALS OR EQUIPMENT AT NO
  ADDITIONAL COST TO THE OWNER WITHIN THE GUARANTEE PERIOD.
- 8. ALL ELECTRICAL WIRING SHALL BE INSTALLED IN CONDUIT. CONDUIT SHALL BE EMT, INTERMEDIATE, OR RIGID GALVANIZED IN ACCORDANCE WITH AND AS PERMITTED BY THE NATIONAL ELECTRICAL CODE OR LOCAL/STATE CODES AS APPLICABLE. UNLESS NOTED OTHERWISE, UNDERGROUND CONDUIT SHALL BE SCHEDULE 40 PVC, 1" MINIMUM, USE RGS SWEEPS AND LISTED PVC TO RGS COUPLINGS TO TRANSITION TO ABOVE GRADE.
- 9. FURNISH AND INSTALL PULL BOXES, JUNCTION, AND DEVICE BOXES OF SUITABLE CODE GAUGE AND SIZE. ALL TERMINATIONS IN IN-GROUND PULL BOXES SHALL BE LIQUID-TIGHT.
- 10. ELECTRICAL WIRES SHALL BE MINIMUM #12 AWG, COPPER, 600 V RATED. #14 AWG COPPER SHALL BE PERMISSIBLE FOR CONTROL CIRCUITRY. AMPACITY RATINGS SHALL BE BASED UPON 75°C RATINGS.
  - A. #14, #12, AND #10 AWG CONDUCTORS SHALL BE "THHN/THWN".

    B. #8 AND LARGER SHALL BE STRANDED "THHN/THWN".
- 11. FLEXIBLE METAL CONDUIT INCLUDING LIQUIDTIGHT SHALL BE PERMITTED WHERE IN ACCORDANCE WITH NATIONAL ELECTRICAL CODE AND LOCAL CODE PROVISIONS. FLEXIBLE METAL CONDUIT SHALL CONTAIN A SEPARATE GROUNDING CONDUCTOR AND BE TERMINATED WITH APPROPRIATE FITTINGS.
- 12. THE DRAWINGS ARE DIAGRAMMATIC AND INTENDED TO DESCRIBE THE WORK REQUIRED. THE ELECTRICAL CONTRACTOR SHALL ACCURATELY FIELD MEASURE AND LAY OUT HIS WORK TO EFFECTIVELY ACHIEVE A COORDINATED INSTALLATION WITH THE SITE LAYOUT AND OTHER TRADES.
- 13. DISCONNECTION, RECONNECTION, AND RELOCATION OF EQUIPMENT SHALL BE COORDINATED SO AS TO CAUSE MINIMAL DISRUPTION OF SERVICE
- 14. ELECTRICAL DISTRIBUTION PANELS ARE EXISTING TO REMAIN, VERIFY LOCATIONS AND SPARE CAPACITY. PROVIDE ALL NEW CIRCUIT BREAKERS FOR THE NEW EQUIPMENT.
- 15. PROVIDE UPDATED TYPEWRITTEN PANELBOARD CIRCUIT DIRECTORIES IN EACH PANELBOARD DOOR IDENTIFYING ALL ACTIVE CIRCUITS AND SPARES. ACTIVE CIRCUITS SHALL DESIGNATE EQUIPMENT SERVED.
- 16. IDENTIFY PANELBOARDS AND USAGE OF PANELBOARD CIRCUIT BREAKERS WITH PLASTIC LAMINOID NAMEPLATES. NAMEPLATES SHALL INDICATE PANEL DESIGNATION, VOLTAGE, AND USE.
- 17. BALANCE ALL LOADS IN PANELBOARDS.
- 18. THE ELECTRICAL CONTRACTOR SHALL PERFORM ALL NECESSARY DEMOLITION WORK AS INDICATED ON THE DRAWINGS.

### ELECTRICAL SYMBOL LEGEND

MOTOR

IN-GROUND PULL-BOX

CIRCUIT BREAKER

SURFACE MOUNTED JUNCTION BOX

EXISTING DISTRIBUTION PANEL

SOLENOID VALVE

GAS DETECTOR

LEAK SENSOR


= CONTACTOR

C OVERLOAD RELAY

EXPLOSION PROOF CONDUIT SEAL


Panelb	oard	ERP1		Voltage		208Y/120V	Phase	3
Panel 7	уре	EXISTING		OCPD	100A M.C.B.		Wire	4
NEMA Type		EXISTING		Mounting	SURFA CE		Buss	100A
Ckt.			Brkr.		Brkr.			Ckt.
No.	DES	Load Description	Size	Phase	Size	Load Description	DES	No.
			*		*			
1	E	DAYTANK	50/1	Α	20/1	OH DOORS	E	2
3	Е	TRAPEZE	20/1	В	20/1	FUEL MANAGEMENT	E	4
5	Е	OH DOORS	20/1	С	20/1	TRAPEZE	E	6
7	E	RECEPTACLES	20/1	Α	20/1	RECEPTACLES	E	8
9	E	RECEPTACLES	20/1	В	20/1	FUEL MONITOR	E	10
11	E	RECEPTACLES	20/1	С	20/1	FUEL MANAGEMENT	E	12
13	Е	RECEPTACLES	20/1	Α	20/1	FIRE ALARM PANEL	E	14
15	Е	TOXALERT PANEL	20/1	В	20/1	TIME CLOCK	E	16
17	E	E SUBMERSIBLE PUMP	20/2	С	20/2	SUBMERSIBLE PUMP		18
19		SUBMERSIBLE PUMP	20/2	Α	2012	SUBMERSIBLE PUMP		20
21	Е	PROPANE DISPENSER 1	15/1	В	20/1	HALON SYSTEM	E	22
23	E	PROPANE DISPENSER 2	15/1	С	20/1	BOOTH CIRC 2	E	24
25	Е	GASOLINE DISPENSER 1	15/1	Α	20/1		E	26
27		GASOLINE DISPENSER 2	15/1	В	20/1		E	28
29	Е	BOOTH CIRC 1	20/1	С	20/1		E	30


anelb	oard	PP-2		Voltage		480Y/277V	Phase	3
anel T	уре	EXISTING		OCPD	M.L.O.		Wire	4
EMA '	Туре	EXISTING		Mounting		SURFACE	Buss	400A
Ckt.			Brkr.		Brkr.			Ckt
No.	DES	Load Description	Size	Phase	Size	Load Description	DES	No.
			*		*			
1				Α				2
3	E	UNKNOWN CIRCUIT	100/3	В	70/3	HV-2-1	E	4
5				С				6
7				Α				8
9	E	UNKNOWN CIRCUIT	100/3	В	70/3	HV-2-2	E	10
11				С				12
13				Α				14
15	E	VEHICLE WASHER	25/3	В	30/3	LIFT	E	16
17				С				18
19				Α				20
21	E	PRESSURE WASHER	30/3	В	35/3	WATER RECLAMATION	E	22
23				С				24
25				Α				26
27	E	AIR COMPRESSOR	50/3	В	20/3	AIR DRYER	E	28
29				С				30
31								32
33	Е	BOOTH UNIT HEATER	15/3		50/3	VACUUM PUMP	E	34
35								36
37				† †				38
39						SPACE		40
41								42

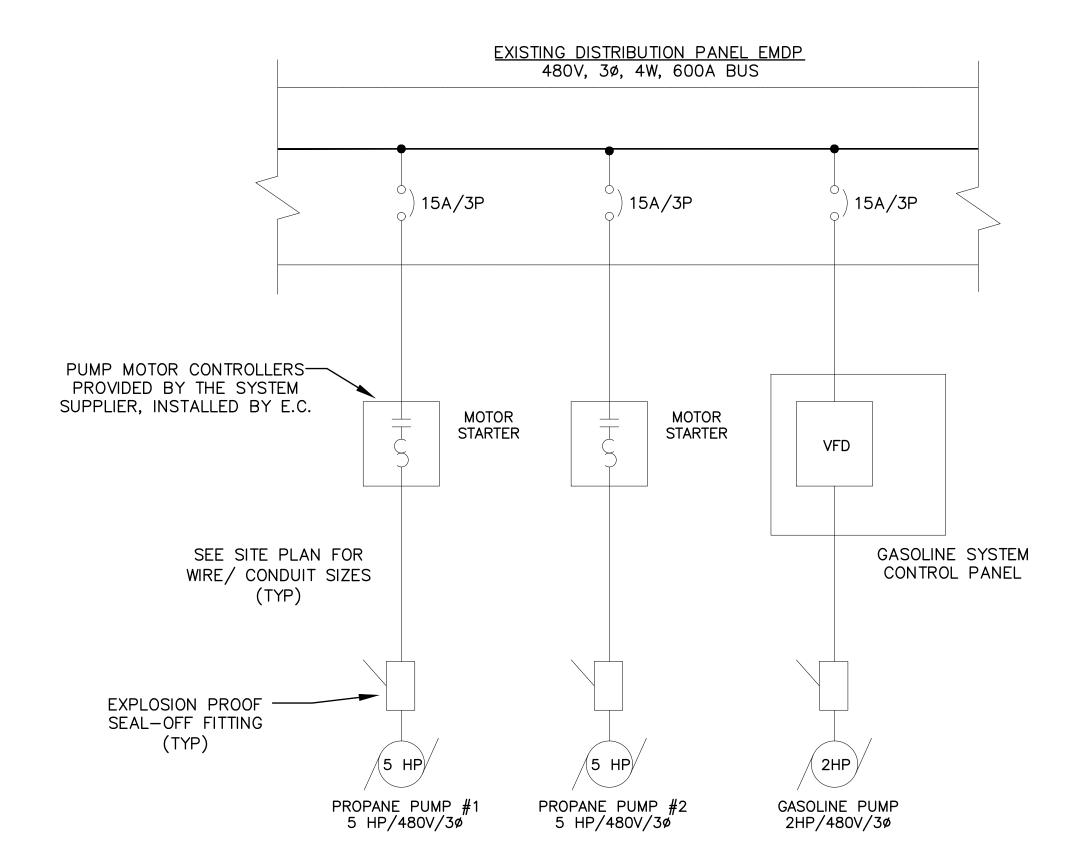

PARTIAL ONE-LINE DIAGRAM

NTS

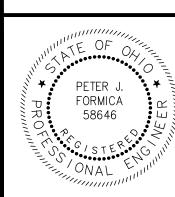

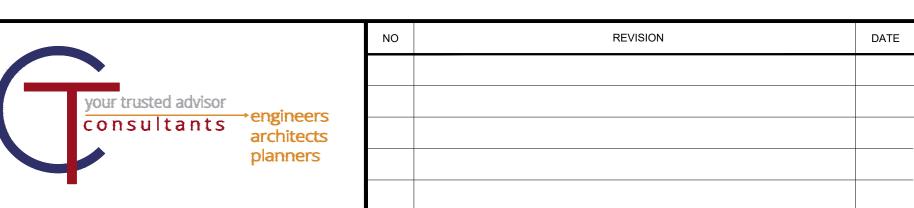

LAKETRAN


### **FUEL TANK UPGRADE**


LAKE COUNTY, OHIO


ISSUED FOR:	BID SET
ISSUE DATE:	05-11-24
SCALE:	AS SHOWN
DESIGNED BY:	PJF
DRAWN BY:	PJF
CHECKED BY:	PJF


ELECTRICAL DETAILS
AND SPECIFICATIONS


PROJECT NO.		
232359		
DISCI	PLINE	
CIVIL		
SHEET NAME		
ELEC-2		
SHEET OF		
_		

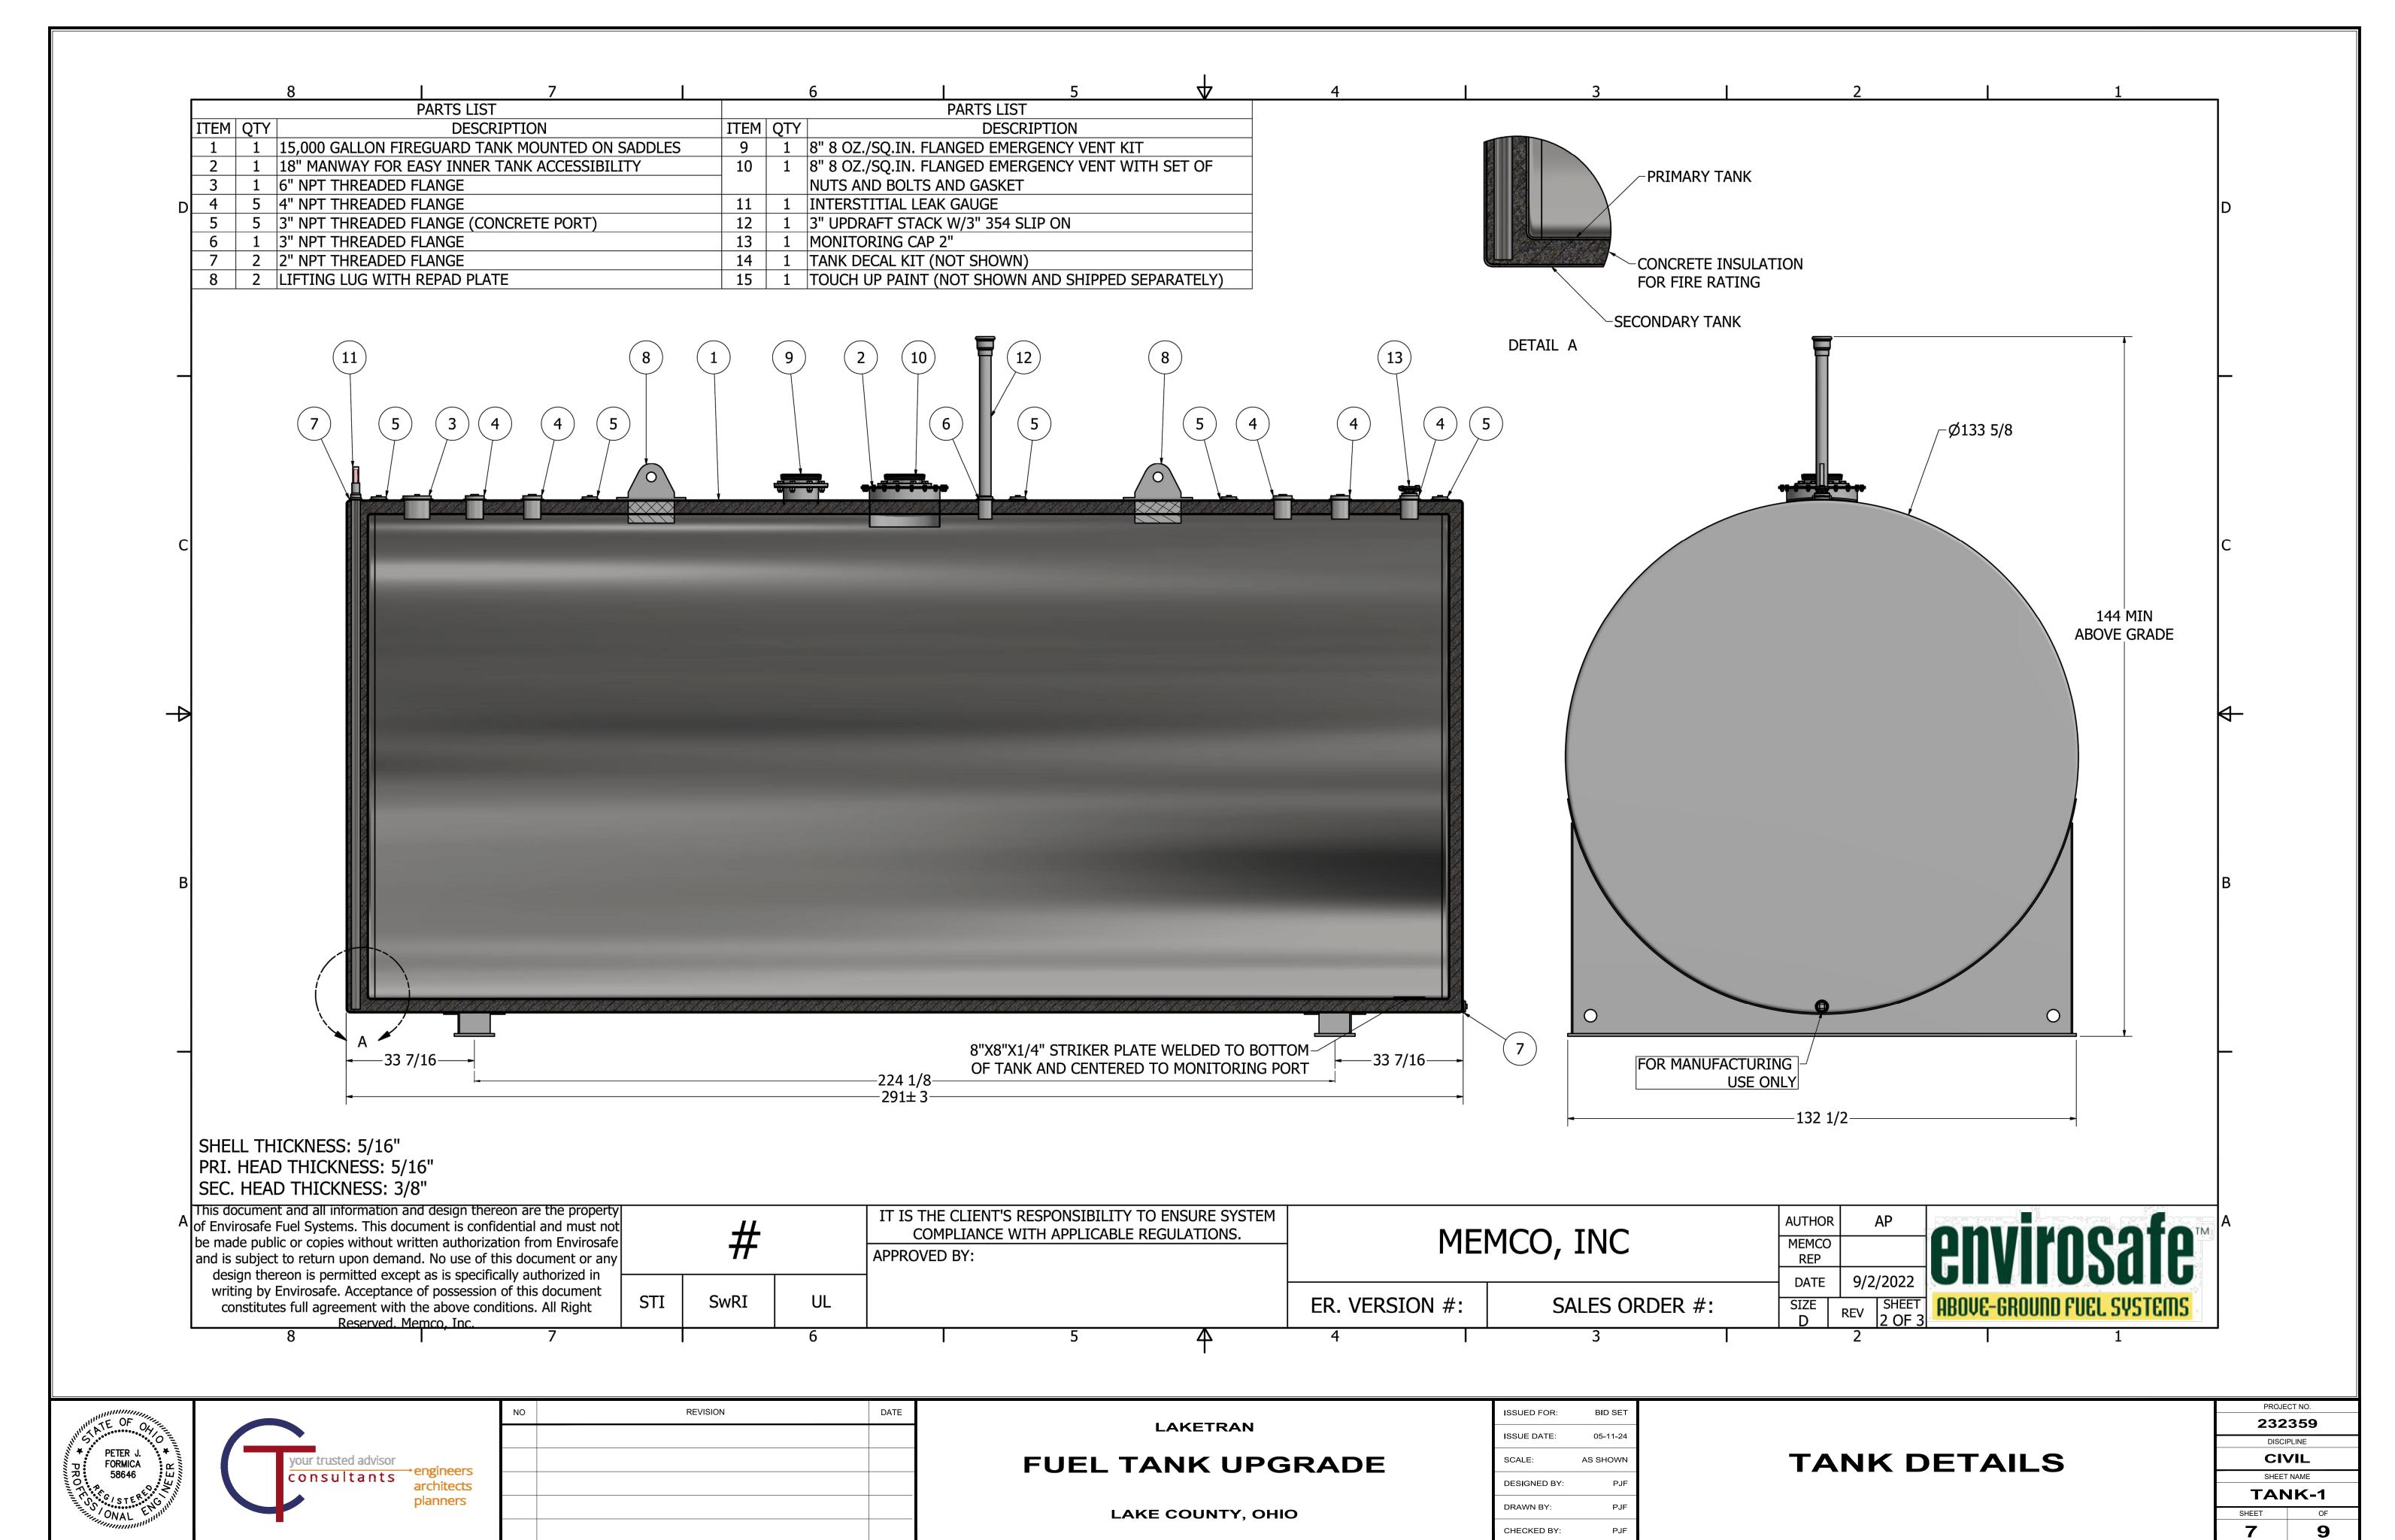

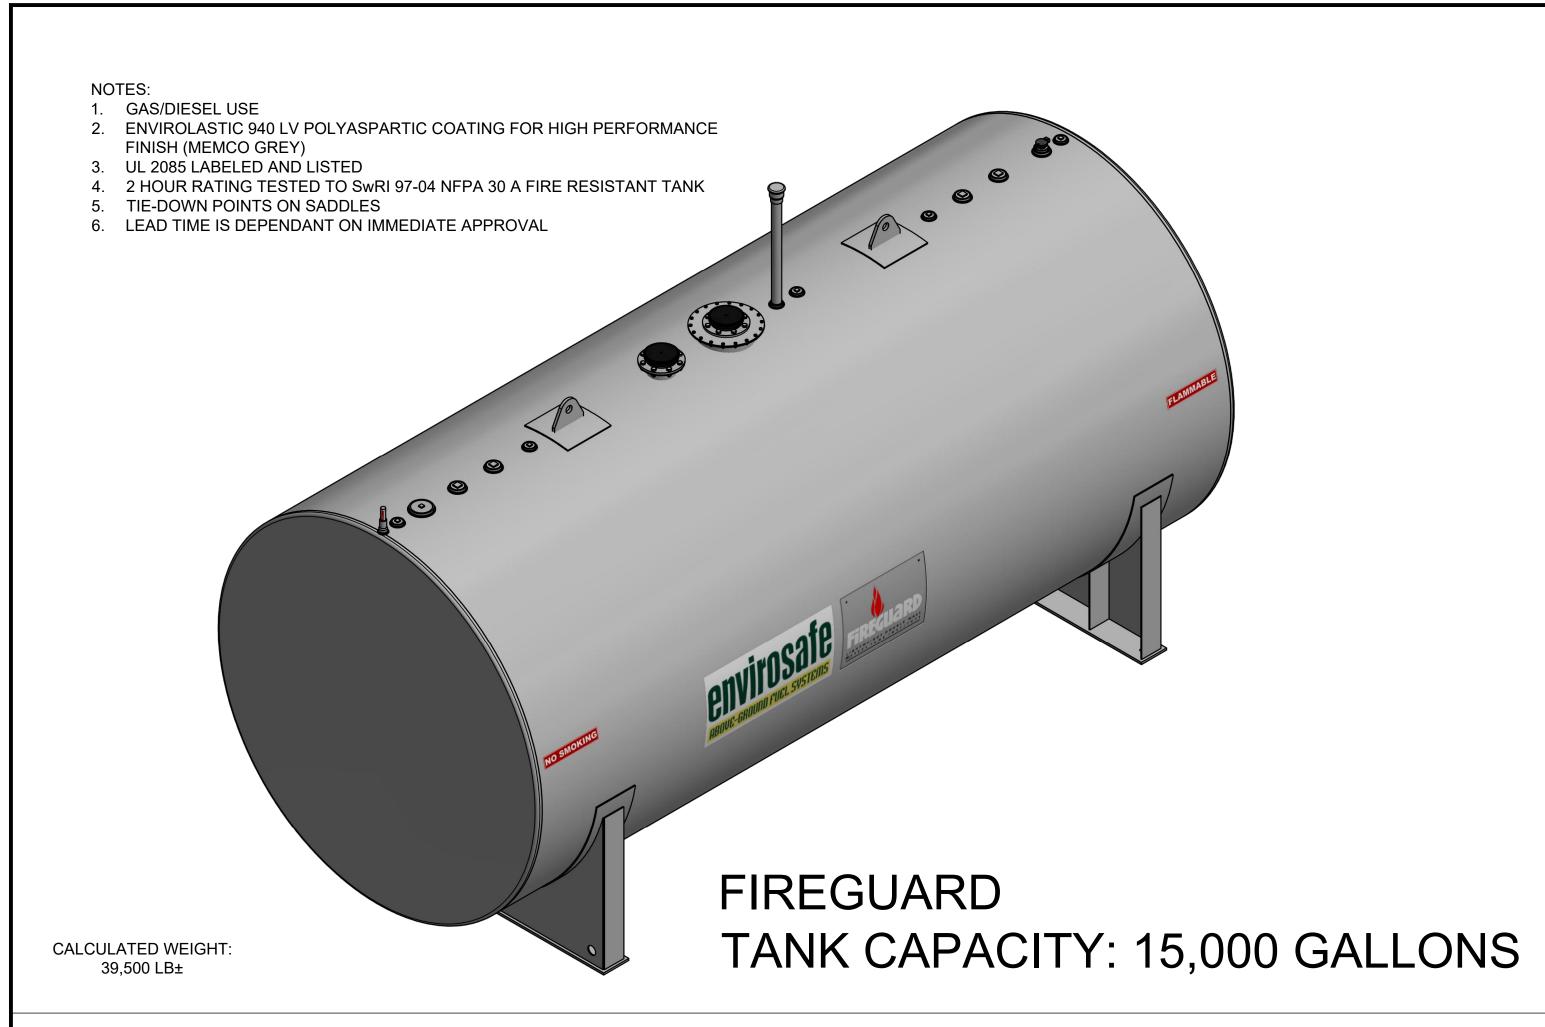

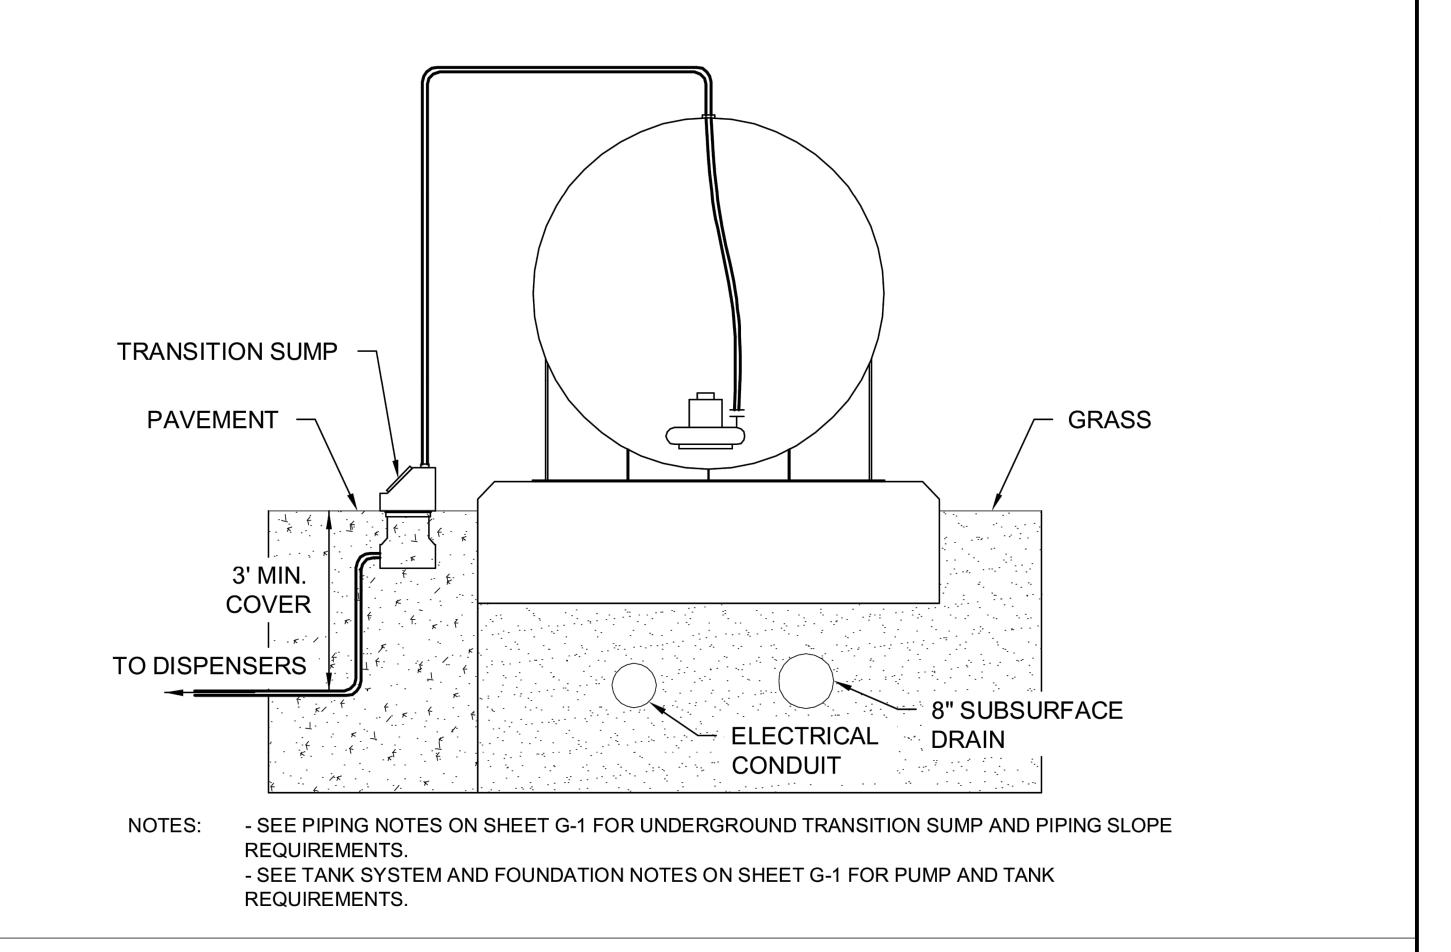

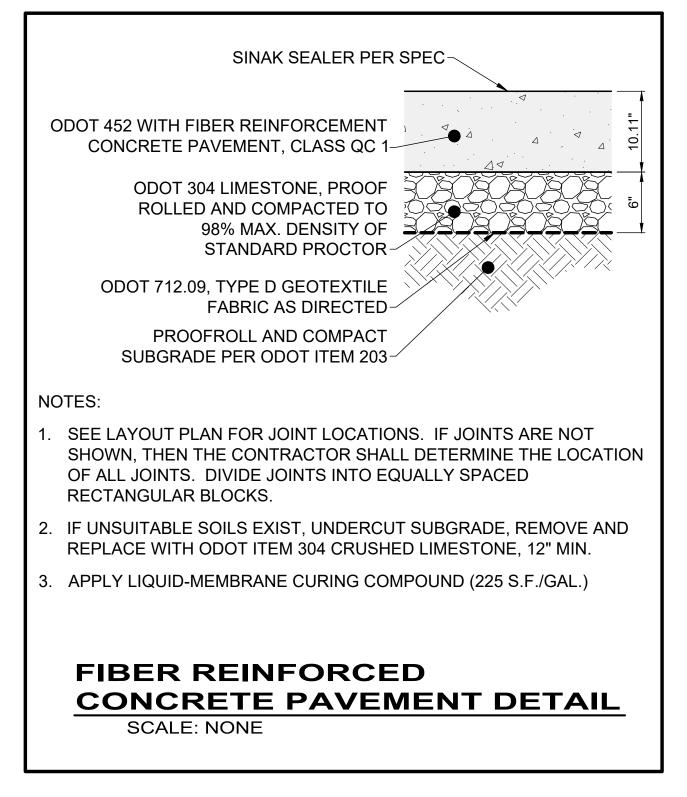

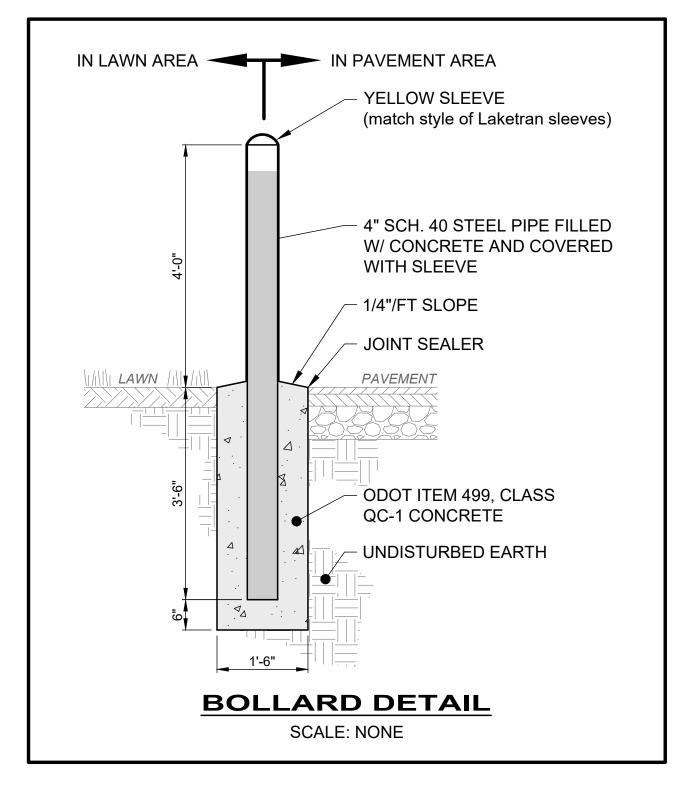

DATE

REVISION





LAKETRAN


**FUEL TANK UPGRADE** 


LAKE COUNTY, OHIO


ISSUED FOR:	BID SET
ISSUE DATE:	05-11-24
SCALE:	AS SHOWN
DESIGNED BY:	PJF
DRAWN BY:	PJF
CHECKED BY:	PJF


**TANK DETAILS** 


PROJE	PROJECT NO.		
232	232359		
DISC	PLINE		
CI	CIVIL		
SHEET	SHEET NAME		
TAN	TANK-2		
SHEET	OF		
l g	9		

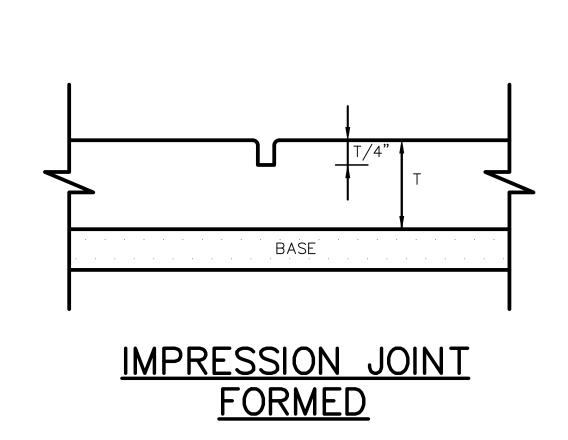

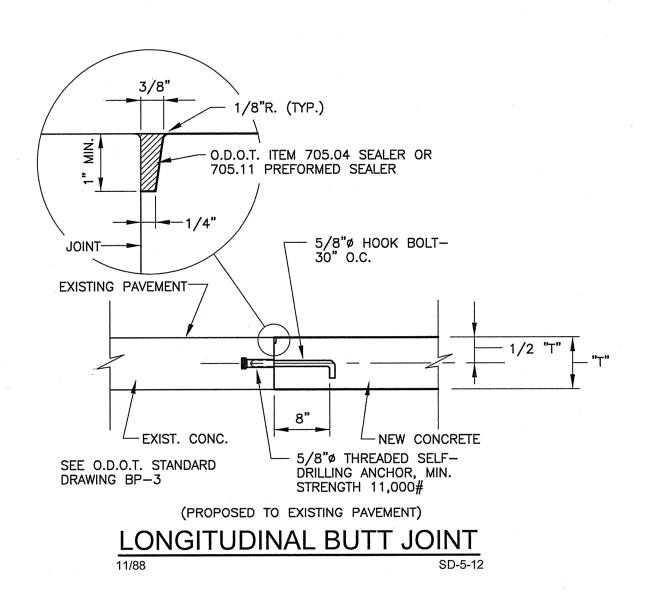

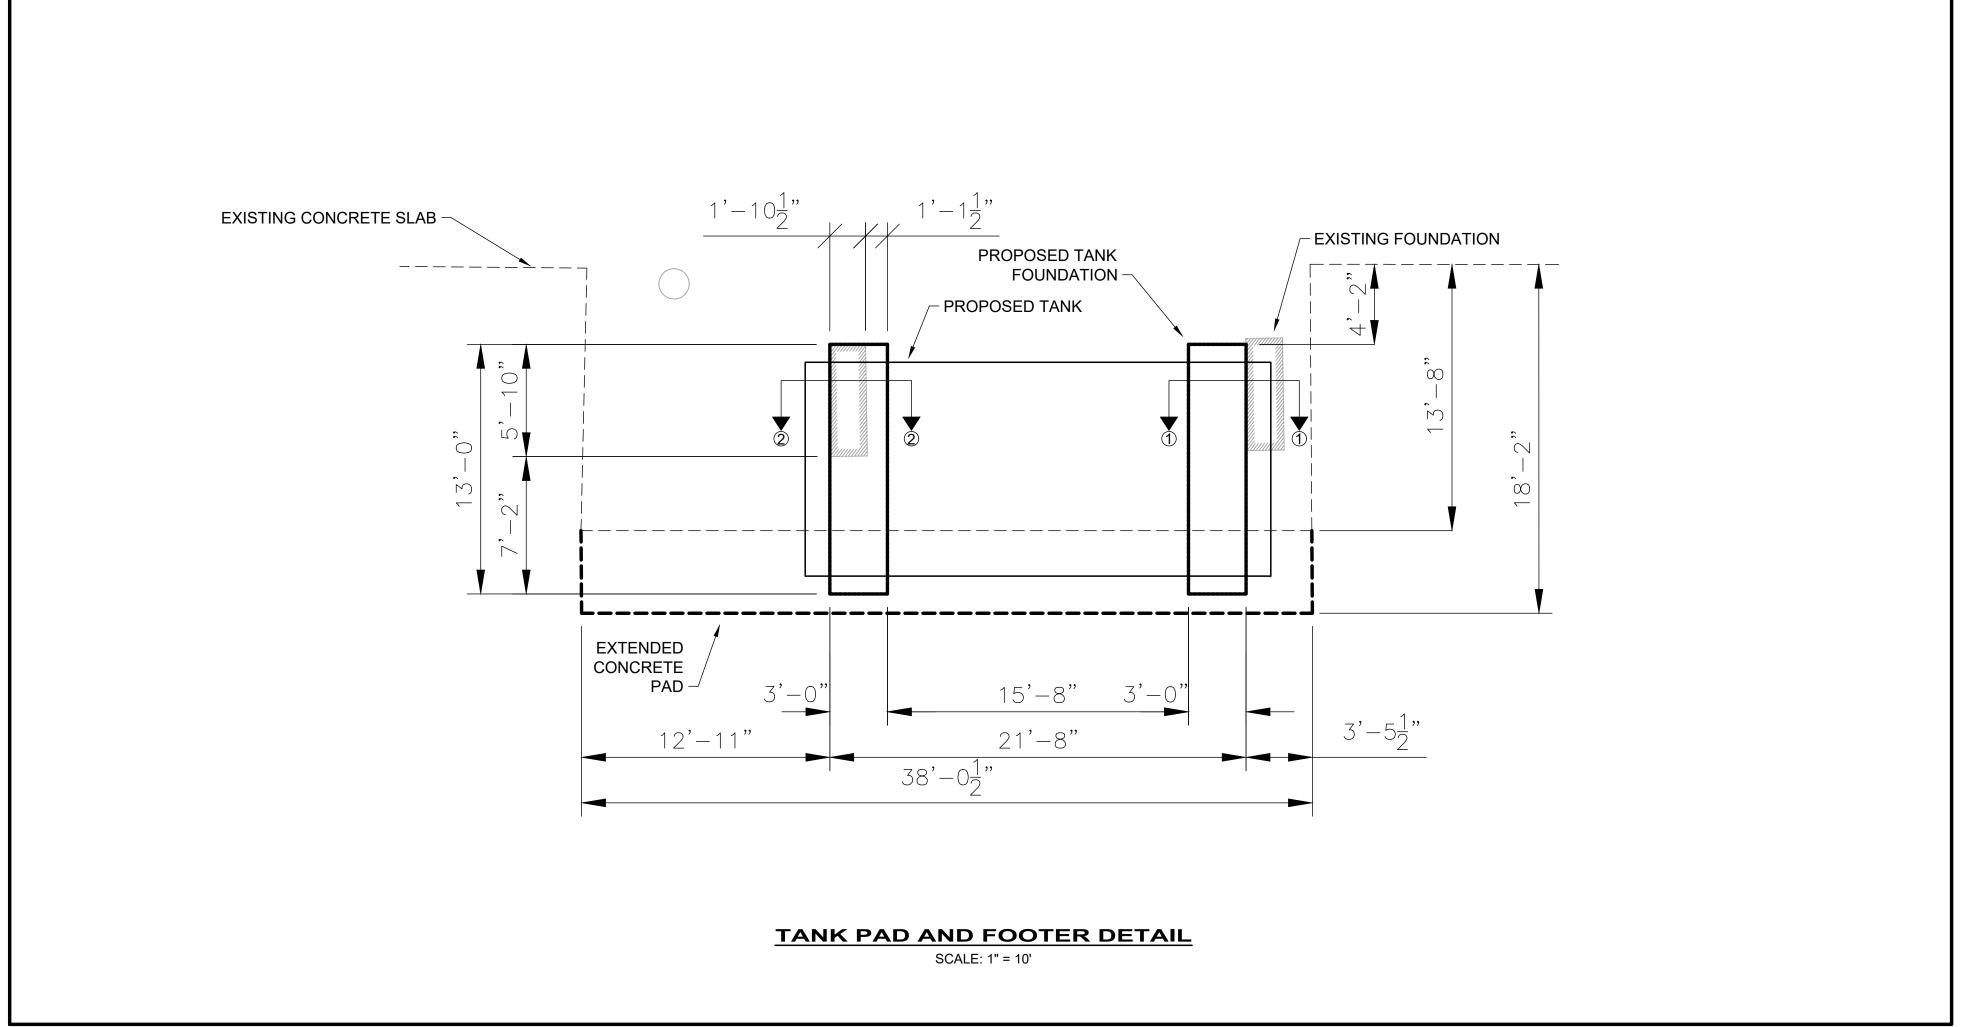

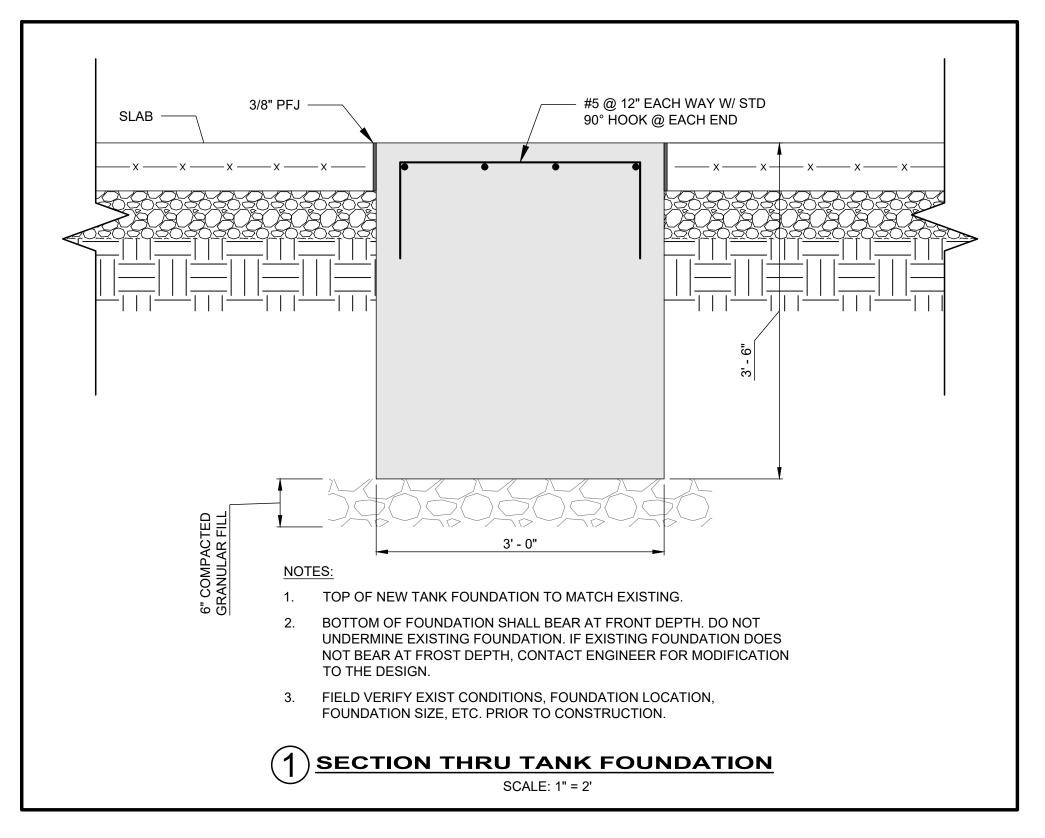

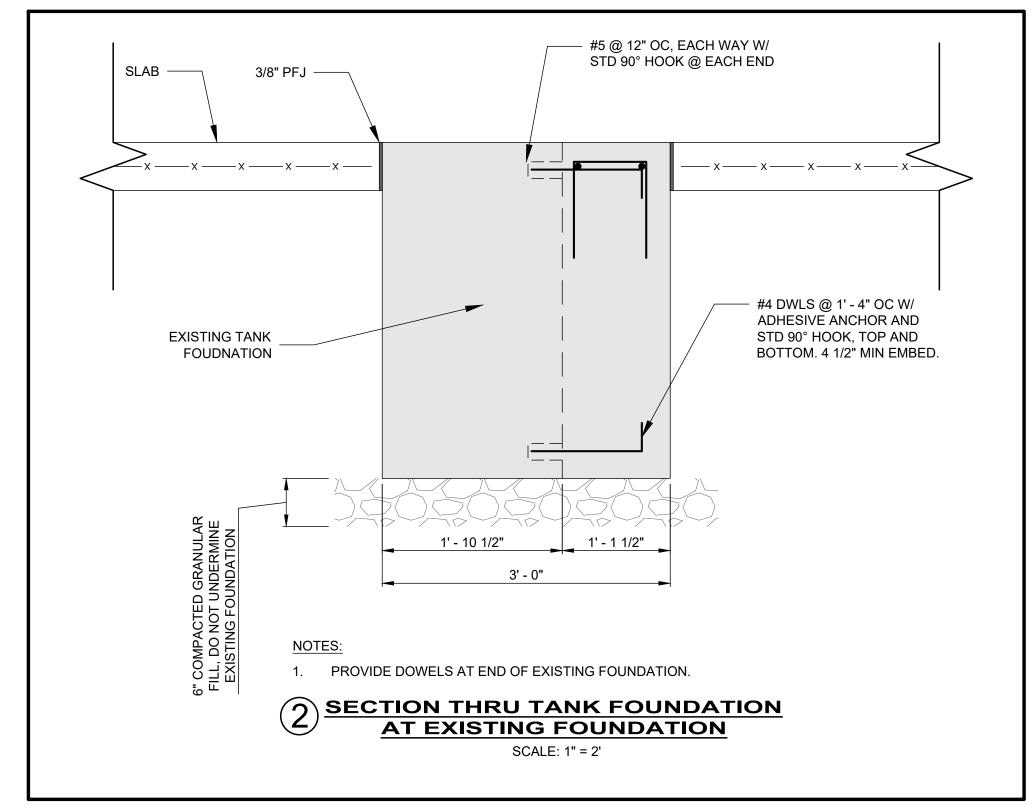





NO REVISION DATE

LAKETRAN

**FUEL TANK UPGRADE** 

LAKE COUNTY, OHIO

ISSUED FOR:	BID SET
ISSUE DATE:	05-11-24
SCALE:	AS SHOWN
DESIGNED BY:	PJF
DRAWN BY:	PJF
CHECKED BY:	PJF

STANDARD DETAILS

PROJECT NO.

232359

DISCIPLINE

CIVIL

SHEET NAME

DET-1