PROJECT DIRECTORY

OWNER

ASHTABULA COUNTY BOARD OF COMMISSIONERS 25 WEST JEFFERSON STREET JEFFERSON, OH 44047



ARCHITECT AND INTERIOR DESIGN

CT CONSULTANTS, INC. 4420 COOPER ROAD SUITE 200 CINCINNATI, OHIO 45242-1818



ASHTABULA COUNTY COURTHOUSE FLOORING REPLACEMENT

25 WEST JEFFERSON STREET JEFFERSON, OH 44047

DRAWING INDEX SITE MAP

		ВУ	BSAB				
		DATE	04/26/2024				
	• - NEW OR REVISED ISSUE	REVISIONS	ISSUE FOR BIDDING				
DWG#	SHEET TITLE		0	1	2	3	4
G0.00	COVER SHEET		•				
G0.01	ABBREVIATIONS & SYMBOLS		•				
D1.01	DEMO OF HAZARDOUS MATERIALS AND WALL BASE		•				
10.01	GENERAL NOTES, FINISH SCHEDULE AND DETAILS		•				
l1.11	FINISH PLAN BUILDING 1, AREA 'A', FIRST FLOOR		•				
l1.12	FINISH PLAN BUILDING 1, AREA 'B', FIRST FLOOR		•				
l1.21	FINISH PLAN BUILDING 1, AREA 'A', SECOND FLOOR		•				
l1.22	FINISH PLAN BUILDING 1, AREA 'B', SECOND FLOOR		•				
12.10	FINISH PLAN BUILDING 2, FIRST FLOOR		•				
12.20	FINISH PLAN BUILDING 2, SECOND FLOOR		•				
12.30	FINISH PLAN BUILDING 2, THIRD FLOOR		•				

13.10 FINISH PLAN BUILDING 3, FIRST FLOOR





your trusted advisor

consultants

architects

planners

EVISIONS DATE BY
G 04/26/2024 BSAB

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 NEHR

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 JFAC

COUNTY T, JEFFERSON, OH 44047

EFFERSON STREET, JEF

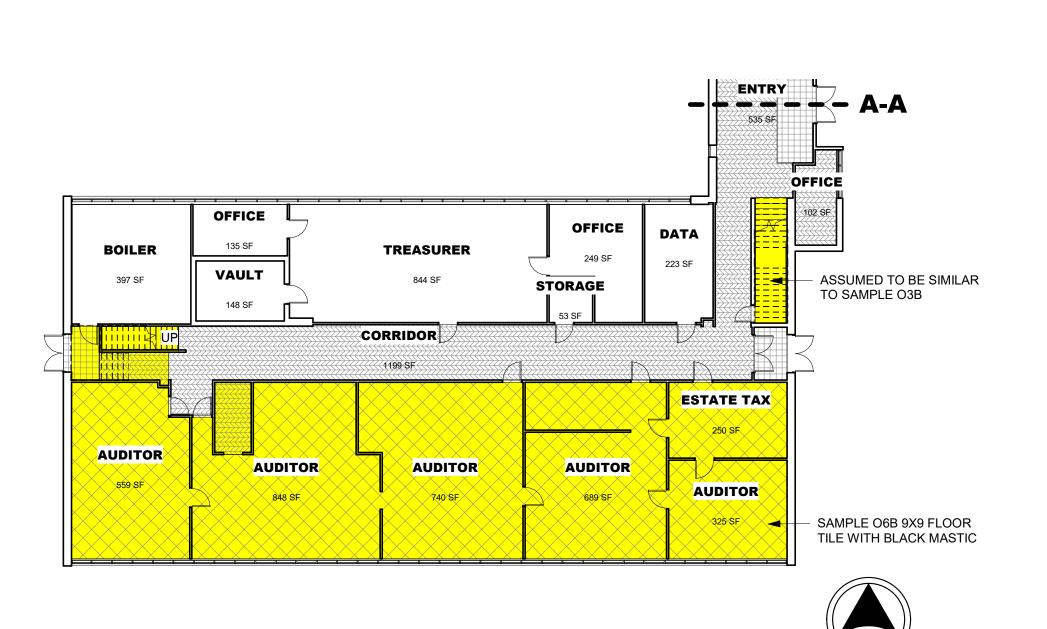
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contract no:
231987

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ACCOUNTS	DRAWING A	BBREVIATIONS	REFERENCE SYMBOLS	DRAWING SYMBOLS
Company	ABOVE ACOUSTICAL / AIR CONDITIONING ACOUSTICAL CEILING TILE AREA DRAIN AMERICANS WITH DISABILITIES ACT ADDITIONAL ADJUSTABLE EF EACH FACE EIFS EXTERIOR INSULATION AND FINISH SYSTEM EB EXPANSION BOLT ES EACH SIDE ELEVATION	LAV LAVATORY LBR LUMBER REV REVISED, REVISION RFG ROOFING RF LINEAR FEET (FOOT) RH RIGHT HAND RHR RIGHT HAND REVERSE LIN LINEAR LKR LOCKER RESIL RESILIENT REV REVISED, REVISION RFG ROOFING RH RIGHT HAND RHR RIGHT HAND REVERSE RL ROOF LEADER RLG RAILING	SHEET SHEET NUMBER WHERE ELEVATION IS DRAWN	
## According 1	ARCHITECT/ENGINEER ABOVE FINISHED FLOOR ABOVE FINISHED GRADE ABOVE FINISHED SLAB AGGREGATE AIR HANDLING UNIT AIR INFILTRATION BARRIER ALIGN ELEV ELEVATOR EMER EMERGENCY EXPANDED POLYSTYRENE BOARD (INSULATION) EQ EQUAL EWC ELECTRIC WATER COOLER EXP EXPOSED EXT EXTERIOR, EXTINGUISHER	LLH LONG LEG HORIZONTAL LLV LONG LEG VERTICAL LOC LOCATION LP LOW POINT LT LIGHT LT LIGHT SAN SANITARY LTWT LIGHT WEIGHT LVR LOUVER SD SMOKE DETECTOR	INTERIOR ELEVATION	DOOR NUMBER
Control Cont	ALUMINUM ANODIZE APPROXIMATE APPROXIMATE ARCHITECT AUXILIARY AUDIO / VISUAL AVERAGE F/ FACE OF FACE OF CONCRTETE F/F FACE TO FACE, FLOOR TO FLOOR F/M FACE OF MASONRY FACE OF STUDS FA FIRE ALARM FD FLOOR DRAIN FDN FOUNDATION	MAINT MAINTENANCE MAS MASOMRY MATL MATERIAL MAX MAXIMUM MECH MECHANICAL MEMB MEMBRANE MEZZ MEZZANINE MFR MANUFACTURER SGL SINGLE SHOWER SHT SHEET SHTHG SHEATHING SHUNG SHUNG SIM SIMILAR	A.101 SHEET NUMBER WHERE	101 WINDOW TYPE
Fig.	BACK TO BACK BOTTOM OF FOOTING BOARD BOUNDARY BUILDER'S HARDWARE MANUFACTURER'S ASSOCIATION BUILDING BLOCKING BACK TO BACK FEC FIRE EXTINGUISHER CABINET FF FINISH FLOOR FF&E FIXTURE, FURNISHING & EQUIPMENT FHC FIRE HOSE CABINET FHR FIRE HOSE RACK FINISH FLOOR FLR FLOOR FACTORY MUTUAL	MISC MISCELLANEOUS MM MILLIMETER MO MASONRY OPENING MOD MODULAR, MODIFY MOV MOVABLE MTD MOUNTED MTL METAL MULL MULLION SM SHEET METAL SPEC SPECIFICATION SQ SQUARE SQ IN SQUARE INCH SQ YD SQUARE YARD SST STAINLESS STEEL ST STAIRS STO SOUND TRANSMISSION CL	ASS	1 INTERIOR PARTITIONS
CAMPAINS	BOTTOM BASE PLATE BEARING BRICK BRACKET BASEMENT BETWEEN BUILT-UP ROOFING FR FRAME FROOTING FUR FUR FURRING FUT FUT FUTURE FVC FIRE VALVE CABINET GA GAUGE GAL GALLON	NA NOT APPLICABLE NFPA NATIONAL FIRE PROTECTION ASSOCIATION NIC NOT IN CONTRACT NO NUMBER NOM NOMINAL NRC NOISE REDUCTION COEFFICIENT STR STRUCTURAL SUBFLOOR SUBFL SUBFLOOR SUPP SUPPLEMENTAL SW SIDEWALK, SHORT WAY SYM SYMMETRICAL	SHEET NUMBER WHERE SECTION IS DRAWN	NN DRAWING NOTE
COMPAND CONTROL OF A CONTRO	BOTH WAYS GALV GALVANIZED GB GRAB BAR CABINET CATCH BASIN CLOSED CIRCUIT TV CONSTRUCTION DOCUMENTS CARD READER CEMENT GALV GALVANIZED GB GRAB BAR GC GENERAL CONTRACTOR GENERATOR GEN GENERAL, GENERATOR GOVERNMENT FURNISHED CONTRACTOR INSTALLED INSTALLED BY GOVERNMENT	OA OVERALL OC ON CENTER OD OUTSIDE DIAMETER OF OUTSIDE FACE OFD OVERFLOW DRAIN OPH OPPOSITE HAND OPNG OPENING TREAD TAB TOP & BOTTOM T&B TOP & BOTTOM TAB TOP OF BEAM TOP OF BEAM TOP OF CONCRETE, TOP OF COLUMN	DETAIL NUMBER ON SHEET	— — NN COLUMN CENTERLINE
CEILING HEIGHT HO	CONTRACTOR FURNISHED CONTRACTOR FURNISHED CONTRACTOR INSTALLED COLD-FORMED METAL FRAMING CORNER GUARD CAST-IN-PLACE CONTROL JOINT GR GRADE GRAD	OWSJ OPEN WEB STEEL JOIST OPR OPERABLE ORD OVERFLOW ROOF DRAIN ORIG ORIGINAL OZ OUNCE PA PUBLIC ADDRESS T/J TOP OF JOIST T/S TOP OF STEEL TB TEST BORING TD TRENCH DRAIN TEL TELEPHONE TEMP TEMPORARY TER TERRAZZO	DETAIL IS DRAWN	— – NN FACE OF BUILDING
COMMETER CONSTRENCE CONSTRENCE HVD HARDWOOD HARD	CEILING CEILING HEIGHT CLOSET COLOR, CLEARANCE CLASSROOM CONCRETE MASONRY UNIT CLEANOUT CLEANOUT COLUMN HC HANDICAPPED HARDY DUTY HEADER HDW HARDWARE HDW HARDWARE HOLOW METAL HORIZ HORIZ HORIZONTAL HP HIGH POINT HEIGHT	PAT PATTERN PB PULL BOX PBD PARTICLEBOARD PCF POUNDS PER CUBIC FOOT PCT PERCENT PERF PERFORATED PERIM PERIMETER PH PHASE TKBD TACKBOARD TOPO TOPOGRAPHY TV TELEVISION TYP TYPICAL UC UNDERCUT UG UNDERGROUND UNDERGROUND UNDERGROUND		
CASEWORK INSUL INSULATION PROP PROPERTY PROPOSED VTR VENT HEILD VENT HOLOGOF CASEWORK INSUL INSULATION PROP PROPERTY PROPOSED VTR VENT HEILD VENT HOLOGOF CENTER INT INTERIOR PSF POUNDS PER SQUARE POOT PSF POUNDS PER SQUARE POOT PSF POUNDS PER SQUARE POOT VMC VINYL WALL COVERING SERIES NUMBER CUBIC FEET INV INVERT PSI POUNDS PER SQUARE FIND PSF POUNDS PSF POUNDS PSF POUNDS PSF POUNDS PS SQUARE FIND PSF POUNDS PSF POUNDS PSF POUNDS PSF POUNDS PSF POUN	COMMUNICATION CONCRETE CONFERENCE CONSTRUCTION CONTINUOUS CONTRACTOR COORDINATE HVAC HEATING, VENTILATING, & AIR CONDITIONING HWD HARDWOOD INTERNATIONAL BUILDING CODE INSIDE DIAMETER ILO IN LIEU OF	PLAM PLASTIC LAMINATE PLAS PLASTER, PLASTIC PLBG PLUMBING PLG PILING PLYWD PLYWOOD PNL PANEL PR PAIR UNF UNFINISHED UNO UNLESS NOTED OTHERWIS USGS UNITED STATES GEOLOGIC SURVEY VAR VARIES VCT VINYL COMPOSITION TILE	NUMBER OF PLAN,	
DEPARTMENT DISCIPLINE: DISCIPLI	CARPET CASEWORK CERAMIC TILE CENTER CUBIC FEET DEPTH DOUBLE INFO INFORMATION INSUL INSULATION INT INTERIOR INV INVERT INV INVERT JAN JANITOR JB JUNCTION BOX	PRKG PARKING PROP PROPERTY, PROPOSED PSF POUNDS PER SQUARE FOOT PSI POUNDS PER SQUARE INCH PT PAINT, POINT, PRESSURE TREATED PTN PARTITION PWR POWER VIF VERIFY IN FIELD VTR VENT THRU ROOF VWC VINYL WALL COVERING WIDE, WIDTH W/ WITH W/O WITHOUT WC WATER CLOSET	SHEET SERIES NUMBER SHEET NUMBER WITHIN SERIES	
	DEPARTMENT DETAIL DRINKING FOUNTAIN DIAMETER DIAGONAL. DIAGRAM DIMENSION DIRECTION KD KNOCK DOWN KIP KILO-POUND KIT KITCHEN KO KNOCKOUT KPL KICKPLATE	QTY QUANTITY WF WIDE FLANGE WH WALL HYDRANT, WATER H R RADIUS, RISER WL WIND LOAD RB RESILIENT BASE WP WATERPROOFING, WORK I RBM REINFORCED BRICK MASONRY WSCT WAINSCOT RBR RUBBER WT WEIGHT RC REINFORCED CONCRETE WWF WELDED WIRE FABRIC	EATER G- GENERAL C - CIVIL A - ARCHITECTURAL I - INTERIOR S - STRUCTURAL M - MECHANICAL	

ABBREVIATIONS & SYMBOLS

G0.01



STORAGE

OFFICE

CORRIDOR

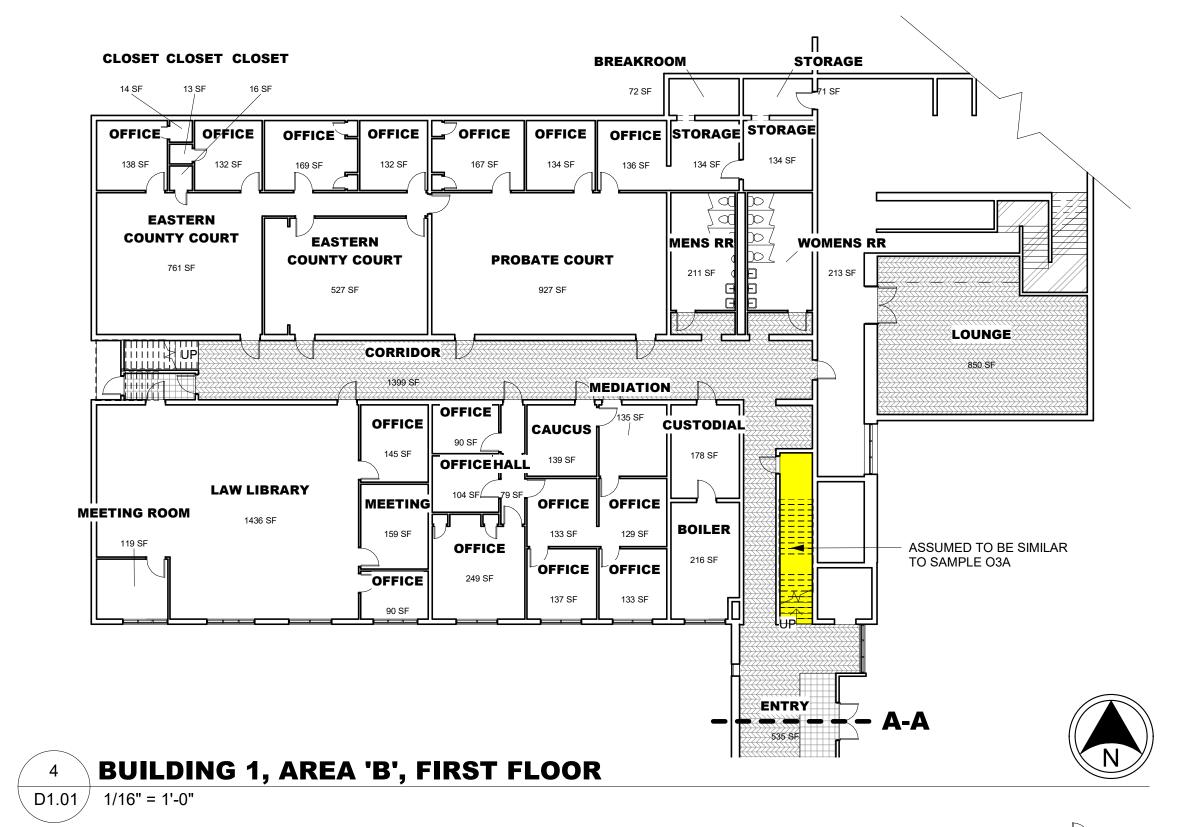
OFFICE B-B

SAMPLE O3B BROWN MASTIC UNDER STAIR

AREAS SUSPECTED OF HAVING HAZARDOUS MATERIALS PRESENT

376 SF

OFFICE

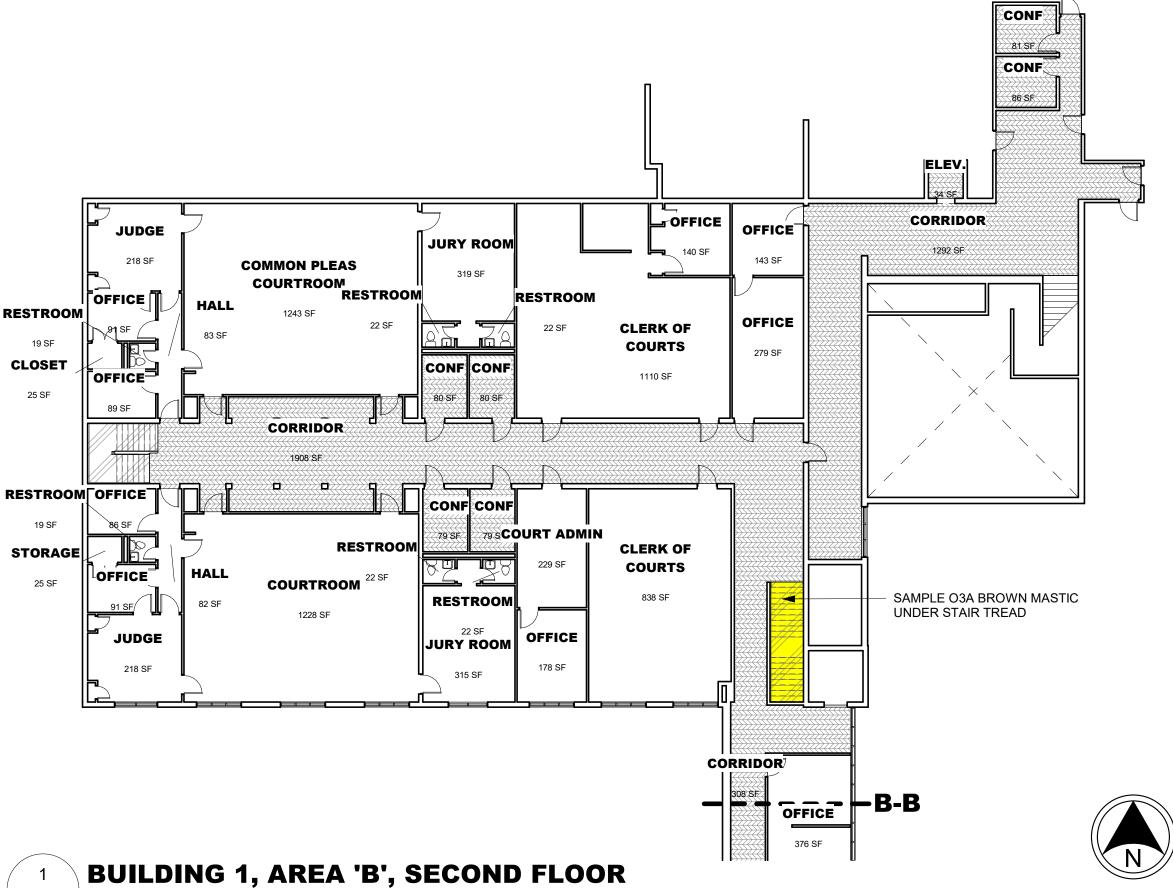


GENERAL DEMOLITION NOTES FOR HAZARDOUS MATERIALS:
REFER TO SPECIFICATIONS AND ASBESTOS SURVEY REPORT FOR ADDITIONAL INFORMATION

- HAZARDOUS MATERIALS ARE PRESENT IN AREAS OF BUILDINGS TO BE SELECTIVELY DEMOLISHED. EXAMINE ASBESTOS SURVEY/REPORT TO BECOME AWARE OF LOCATIONS WHERE HAZARDOUS MATERIALS ARE PRESENT. HAZARDOUS MATERIALS SHALL BE PROPERLY REMOVED AND DISPOSED OF ACCORDING TO ALL LOCAL, STATE, AND FEDERAL REGULATIONS, BY A LICENSED ABATEMENT CONTRACTOR. DO NOT DISTURB HAZARDOUS MATERIALS, OR ITEMS SUSPECTED OF CONTAINING HAZARDOUS MATERIALS, EXCEPT UNDER THE SUPERVISION OF A LICENSED ABATEMENT CONTRACTOR, AND ONLY IN AREAS AND SPACES SCHEDULED TO RECEIVE NEW FLOORING MATERIALS.
- AREAS NOTED AS "SUSPECTED OF HAVING HAZARDOUS MATERIALS PRESENT" IS BASED ON FIELD SAMPLING IN LIMITED AREAS AND IS ASSUMED TO ONLY BE PRESENT IN BUILDING 1, AREA A, AS INDICATED.
- NO HAZARDOUS MATERIALS WERE FOUND TO BE PRESENT IN BUILDINGS 2 AND 3, SO IT IS NOT EXPECTED THAT HAZARDOUS MATERIALS WILL BE ENCOUNTERED IN THE WORK AT THESE LOCATIONS. IF SUSPECTED HAZARDOUS MATERIALS ARE ENCOUNTERED, DO NOT DISTURB; IMMEDIATELY NOTIFY ARCHITECT AND OWNER SO MATERIALS CAN BE REVIEWED AND QUANTIFIED. IF DETERMINED TO BE HAZARDOUS MATERIALS, THEY SHALL BE REMOVED BY THE LISCENSED ABATEMENT CONTRACTOR PER THE UNIT PRICE SCHEDULE.
- FOR THE PURPOSES OF BIDDING AND CONSTRUCTION, THE CONTRACTOR SHALL ASSUME THE REMOVAL OF 6,000 SQUARE FEET OF 9X9 VINYL COMPOSITION TILE AND MASTIC AND 200 SQUARE FEET OF STAIR TREADS WITH BROWN MASTIC. ACTUAL QUANTITIES REMOVED SHALL BE MEASURED AND ADJUSTED PER THE

GENERAL WALL BASE DEMOLITION NOTES (TYPICAL UNLESS NOTED OTHERWISE):

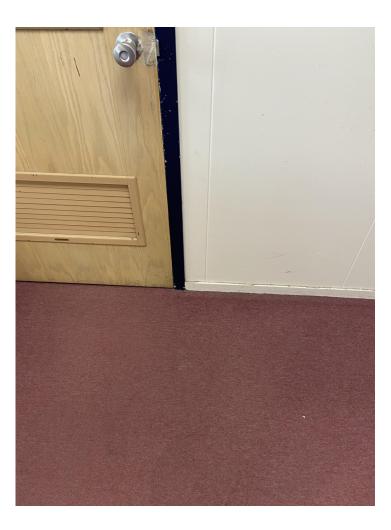
- THE GENERAL DESIGN INTENT IS TO REPLACE EXISITNG WALL BASE IN KIND,
- SPACES AND AREAS THAT HAVE EXISTING RUBBER/VINYL COVE BASE THAT IS TO BE REMOVED SHALL RECEIVE NEW RUBBER WALL BASE AT THE COMPLETION OF
- THE FLOORING INSTALLATION. SPACES AND AREAS THAT HAVE EXISTING PROFILED WOOD BASEBOARDS, THE WOOD BASEBOARD SHALL REMAIN; REMOVE TOE MOULDING IF PRESENT AND REPLACE WITH NEW TOE MOULDING AT THE COMPLETION OF THE FLOORING
- INSTALLATION. PAINT OR STAIN NEW TOE MOULDING TO MATCH BASEBOARDS. SPACES AND AREAS THAT HAVE EXISTING NON-PROFILED WOOD BASEBOARDS. THE WOOD BASEBOARD SHALL BE REMOVED. PROVIDE NEW RUBBER BASE AT THE COMPLETION OF THE FLOORING INSTALLATION.





WALL BASE EXAMPLE - NOTE 'B'





WALL BASE EXAMPLE - NOTE 'D'



RECORDER

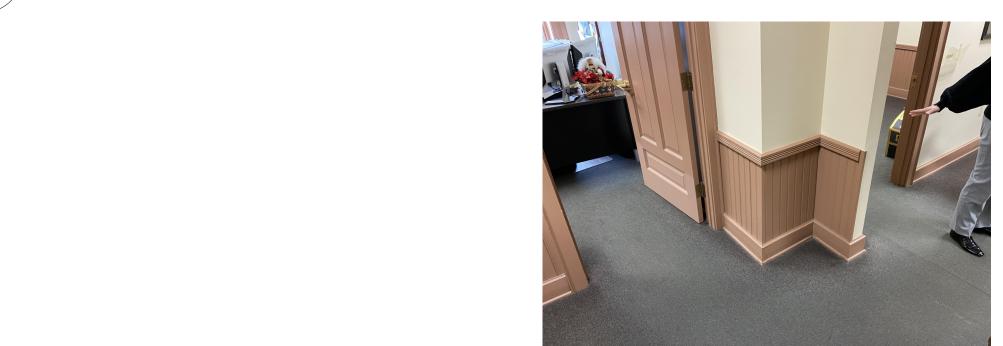
SAMPLE O6B 9X9 FLOOR

TILE WITH BLACK MASTIC

BUILDING 1, AREA 'A', FIRST FLOOR

D1.01 / 1/16" = 1'-0"

CONFERENCE







SCALE: As indicated CONTRACT NO: 231987

D1.01

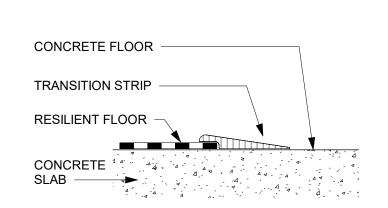
WALL

ABULA COURTHOUSE FLOORING
ASHTABULA COUNTY
JEFFERSON STREET, JEFFERSON, OH 4404

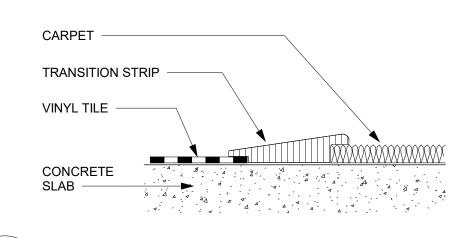
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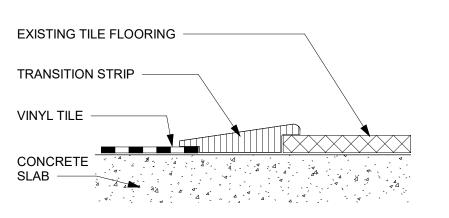
			BASI	S OF DESIGN FINISH SCH	EDULE		
	ITEM	DESCRIPTION	MANUFACTURER	STYLE	SIZE	COLOR	APPROXIMATE QUANTITIES
RUBBER	RB-1	RUBBER BASE	ROPPE CORPORATION	TRADITIONAL RUBBER, COVE BASE	4" COVE, 1/8" GAUGE	114 - LUNAR DUST	CONTRACTOR TO VERIFY EACH EXTENT. NOT ALL WALLS WITHIN SCOPE TO RECEIVE NEW RUBBER BASE. ALL PROFILED WOOD BASE TO REMAIN.
BASE	RB-2	RUBBER BASE	ROPPE CORPORATION	TRADITIONAL RUBBER, COVE BASE	4" COVE, 1/8" GAUGE	147 - LIGHT BROWN	
CARPET	C-1	CARPET TILE; OFFICE AREAS	J&J FLOORING GROUP	INTEGRAL - 7310	24 X 24	INNATE - 2722	615 SY
	C-2	WALK-OFF CARPET	J&J FLOORING GROUP	CATWALK II - 7268	24 X 24	SPOTLIGHT - 1427	30 SY
	C-3	CARPET TILES; OFFICE AREAS	J&J FLOORING GROUP	FAST TRACK - 7578	18 X 36	BREAKOUT - 3218	425 SY
	C-4	WALK-OFF CARPET	J&J FLOORING GROUP	CATWALK II - 7268	24 X 24	GLITTERATI - 1424	25 SY
LUXURY VINYL	LVT-1	LUXURY VINYL TILE	J&J FLOORING GROUP	LEGEND - V5010	18" X 36"	TALE - 1057	11,325 SF
TILE (LVT)	LVT-2	LUXURY VINYL TILE	J&J FLOORING GROUP	CLASSICS II - V5023	9" X 48"	RARITY - 1091	6,910 SF
STAIR	ST-1 ST-2	RUBBER STAIR TREAD & LANDING TILE RUBBER STAIR TREAD & LANDING TILE	ROPPE CORPORATION ROPPE CORPORATION	SYMMETRY SYMMETRY		S194 - BURNT UMBER S174 - SMOKE	640 SF 235 SF







VINYL TILE TO CARPET 10.01 / 6" = 1'-0"



VINYL TILE TO EXISTING CERAMIC TILE 10.01 / 6" = 1'-0"

GENERAL DEMOLITION AND CONSTRUCTION NOTES: REFER TO SPECIFICATIONS FOR ADDITIONAL INFORMATION

- VERIFY EXISTING CONDITIONS IN FIELD AND NOTIFY ARCHITECT AND OWNER OF ANY
- REMOVE EXISTING FLOOR COVERINGS, WALL BASE, MOULDINGS, AND TRANSITION "STRIPS" IN ROOMS OR SPACES SCHEDULED TO RECEIVE NEW FLOORING MATERIALS, UNLESS NOTED OTHERWISE. COORDINATE LIMITS OF DEMOLITION WORK WITH NEW
- PROTECT EXISTING WALLS, CEILINGS, FLOORS, FURNITURE, EQUIPMENT, AND OTHER SURFACES THAT ARE TO REMAIN, AND RESTORE TO ORIGINAL CONDITION IF DAMAGED
- DURING THE COURSE OF COMPLETING THE DEMOLITION WORK. WHERE REMOVING PORTIONS OF CONCRETE. USE A SAW TO CUT CLEAN, SHARP LINES. WHERE ADJACENT OR INTERSECTING CONSTRUCTION IS TO REMAIN, TRIM, GRIND, SCRAPE, OR SAND FACES OF DEMOLISHED ITEMS FLUSH WITH ADJACENT SURFACES
- WHERE ADJACENT CONSTRUCTION HAS BEEN REMOVED, PATCH AND FINISH EXISTING SURFACES TO REMAIN. WHERE CUTTING AND PATCHING OCCURS, PROVIDE FINISH
- MATERIALS TO MATCH EXISTING, INCLUDING PAINT COLORS IF TOUCHUP PAINTING IS DURING DEMOLITION, ISOLATE AREAS OF WORK TO CONTAIN DUST AND DEBRIS WITHIN THE AREAS OF WORK BY MEANS OF TEMPORARY PARTITIONS AND WALK-OFF MATS.
- PROVIDE FILTRATION UNITS AS REQUIRED. MAINTAIN ACCESS TO ALL EXITS, MEANS OF EGRESS, FIRE EXTINGUISHERS, AND ELEVATORS. PROVIDE TEMPORARY MEANS OF EGRESS IF SITE CONDITIONS WILL NOT ALLOW KEEPING ALL PATHS CLEAR.
- ALL CONSTRUCTION DEBRIS SHALL BE REMOVED EACH DAY, AND CONSTRUCTION AREAS SHALL BE CLEANED. PROVIDE AND MAINTAIN DUMPSTERS AND OTHER WASTE DISPOSAL FACILITIES. COORDINATE WITH OWNER FOR PROPOSED LOCATION OF THE DUMPSTERS.
- REASONABLE EFFORTS HAVE BEEN MADE TO ACCURATELY PRODUCE FLOOR PLANS; HOWEVER, THEIR ACCURACY CANNOT BE GUARANTEED. IT SHALL BE THE RESPONSIBILITY OF THE CONTRACTOR TO VERIFY QUANTITIES. QUANTITIES INCLUDED ON DRAWINGS ARE FOR ESTIMATES ONLY AND SHALL BE VERIFIED BY THE
- CONTRACTOR PRIOR TO BIDDING. PRIOR TO THE INSTALLATION OF PROPOSED FLOORING MATERIALS, PATCH AND LEVEL SUBFLOOR OR CONCRETE SLAB. FEATHER EDGES OF PATCHING TO PROVIDE A SMOOTH TRANSITION.
- UNLESS OTHERWISE NOTED, WHERE CARPET, TILE, AND STAIR TREADS ARE PROPOSED, INSTALL FLOORING MATERIAL WALL TO WALL, AND INTO ACCESSIBLE SPACES. PROVIDE WALL BASE AT PERIMETER OF EACH ROOM OR SPACE. FLOORING AND BASE IS NOT REQUIRED TO BE INSTALLED UNDERNEATH OR BEHIND BUILT-IN ITEMS SUCH AS CASEWORK.
- PROVIDE TRANSITIONS BETWEEN DIFFERENT FLOORING MATERIALS. REFER TO DRAWINGS FOR SCHEDULE OF TRANSITION TYPES AND LOCATIONS.
- CONTRACTOR SHALL BE SOLELY RESPONSIBLE FOR MOVING, CATALOGING, STORING, AND RESETTING EXISTING FUTNITURE, FIXTURES, AND EQUIPMENT AS REQUIRED TO FACILITATE THE WORK. MEANS AND METHODS FOR MOVING/STORING FF&E IS THE RESPONSIBILTY OF THE CONTRACTOR AND MAY INCLUDE CREATING "SWING SPACE" WITHIN THE BUILDING OR PROVIDING TEMPORARY STORAGE FACILITIES ON SITE.
- COORDINATE WITH OWNER AND PHASING REQUIREMENTS. WORK IN PUBLIC SPACES, CORRIDORS, AND THE CLERK OF COURTS TITLE OFFICE SHALL BE PERFORMED AFTER REGULAR BUSINESS HOURS AND/OR DURING WEEKEND HOURS. COORDINATE WITH OWNER AND PHASING REQUIREMENTS.

GENERAL PHASING NOTES:

REFER TO SPECIFICATIONS FOR ADDITIONAL INFORMATION

- PHASING SHALL BE CLOSELY COORDINATED WITH OWNER AND THEIR OPERATIONS. CONTRACTOR SHALL RECEIVE WRITTEN APPROVAL OF PROPOSED PHASING BY OWNER BEFORE BEGINNING WORK.
- CONTRACTOR SHALL BE RESPONSIBLE FOR DEVELOPING A PHASING PLAN INDICATING THEIR SYSTEMATIC APPROACH TO EXECUTE THE WORK WITHIN EACH BUILDING. THE INTENT IS TO EXECUTE THE WORK WHILE MINIMIZING DISRUPTIONS TO OWNER OPERATIONS BY PERFORMING WORK IN DESIGNATED AREAS (PHASES), WITH EACH PHASE BEING SUBSTANTIALLY COMPLETE BEFORE BEGINNING WORK ON THE NEXT PHASE. WORK MAY BE PERFORMED IN DIFERENT BUILDINGS OR AREAS CONCURRENTLY IF APPROVED BY OWNER
- PHASES SHALL BE PROPOSED BY CONTRACTOR BASED ON THEIR PAST EXPERIENCE, SIZE OF WORK FORCE, PROPOSED APPROACH TO MOVE OUT/MOVE IN FOR FF&E, AND OTHER RELATED FACTORS. PHASES SHALL BE IDENTIFIED BY BUILDING, FLOOR, WING, AND SPECIFIC AREAS.
- BEFORE COMMENCING WORK OF EACH PHASE, SUBMIT AN UPDATED COPY OF CONTRACTOR'S CONSTRUCTION SCHEDULE, SHOWING THE SEQUENCE, COMMENCEMENT, COMPLETION DATES, AND MOVE OUT AND MOVE IN DATES OF
- OWNER'S PERSONNEL FOR EACH PHASE OF THE WORK. INDICATE WORK IN PUBLIC SPACES, CORRIDORS, AND THE CLERK OF COURTS TITLE OFFICE AS SEPARATE PHASES, AS WORK IN THESE AREAS SHALL BE PERFORMED
- AFTER REGULAR BUSINESS HOURS AND/OR DURING WEEKEND HOURS. PROVIDE TEMPORARY PROTECTION AS REQUIRED TO MINIMIZE DUST DISPERSION THROUGHOUT THE SPACES. TEMPORARY PROTECTION CAN INCLUDE TEMPORARY BARRICADES, WALK-OFF MATS, AND ADDITIONAL FILTERS ON RETURN GRILLS OF THE HVAC SYSTEM. PROVIDE THE TEMPORARY PROTECTION INFORMATION ON THE PHASING PLANS TO THE OWNER AS REQUIRED.



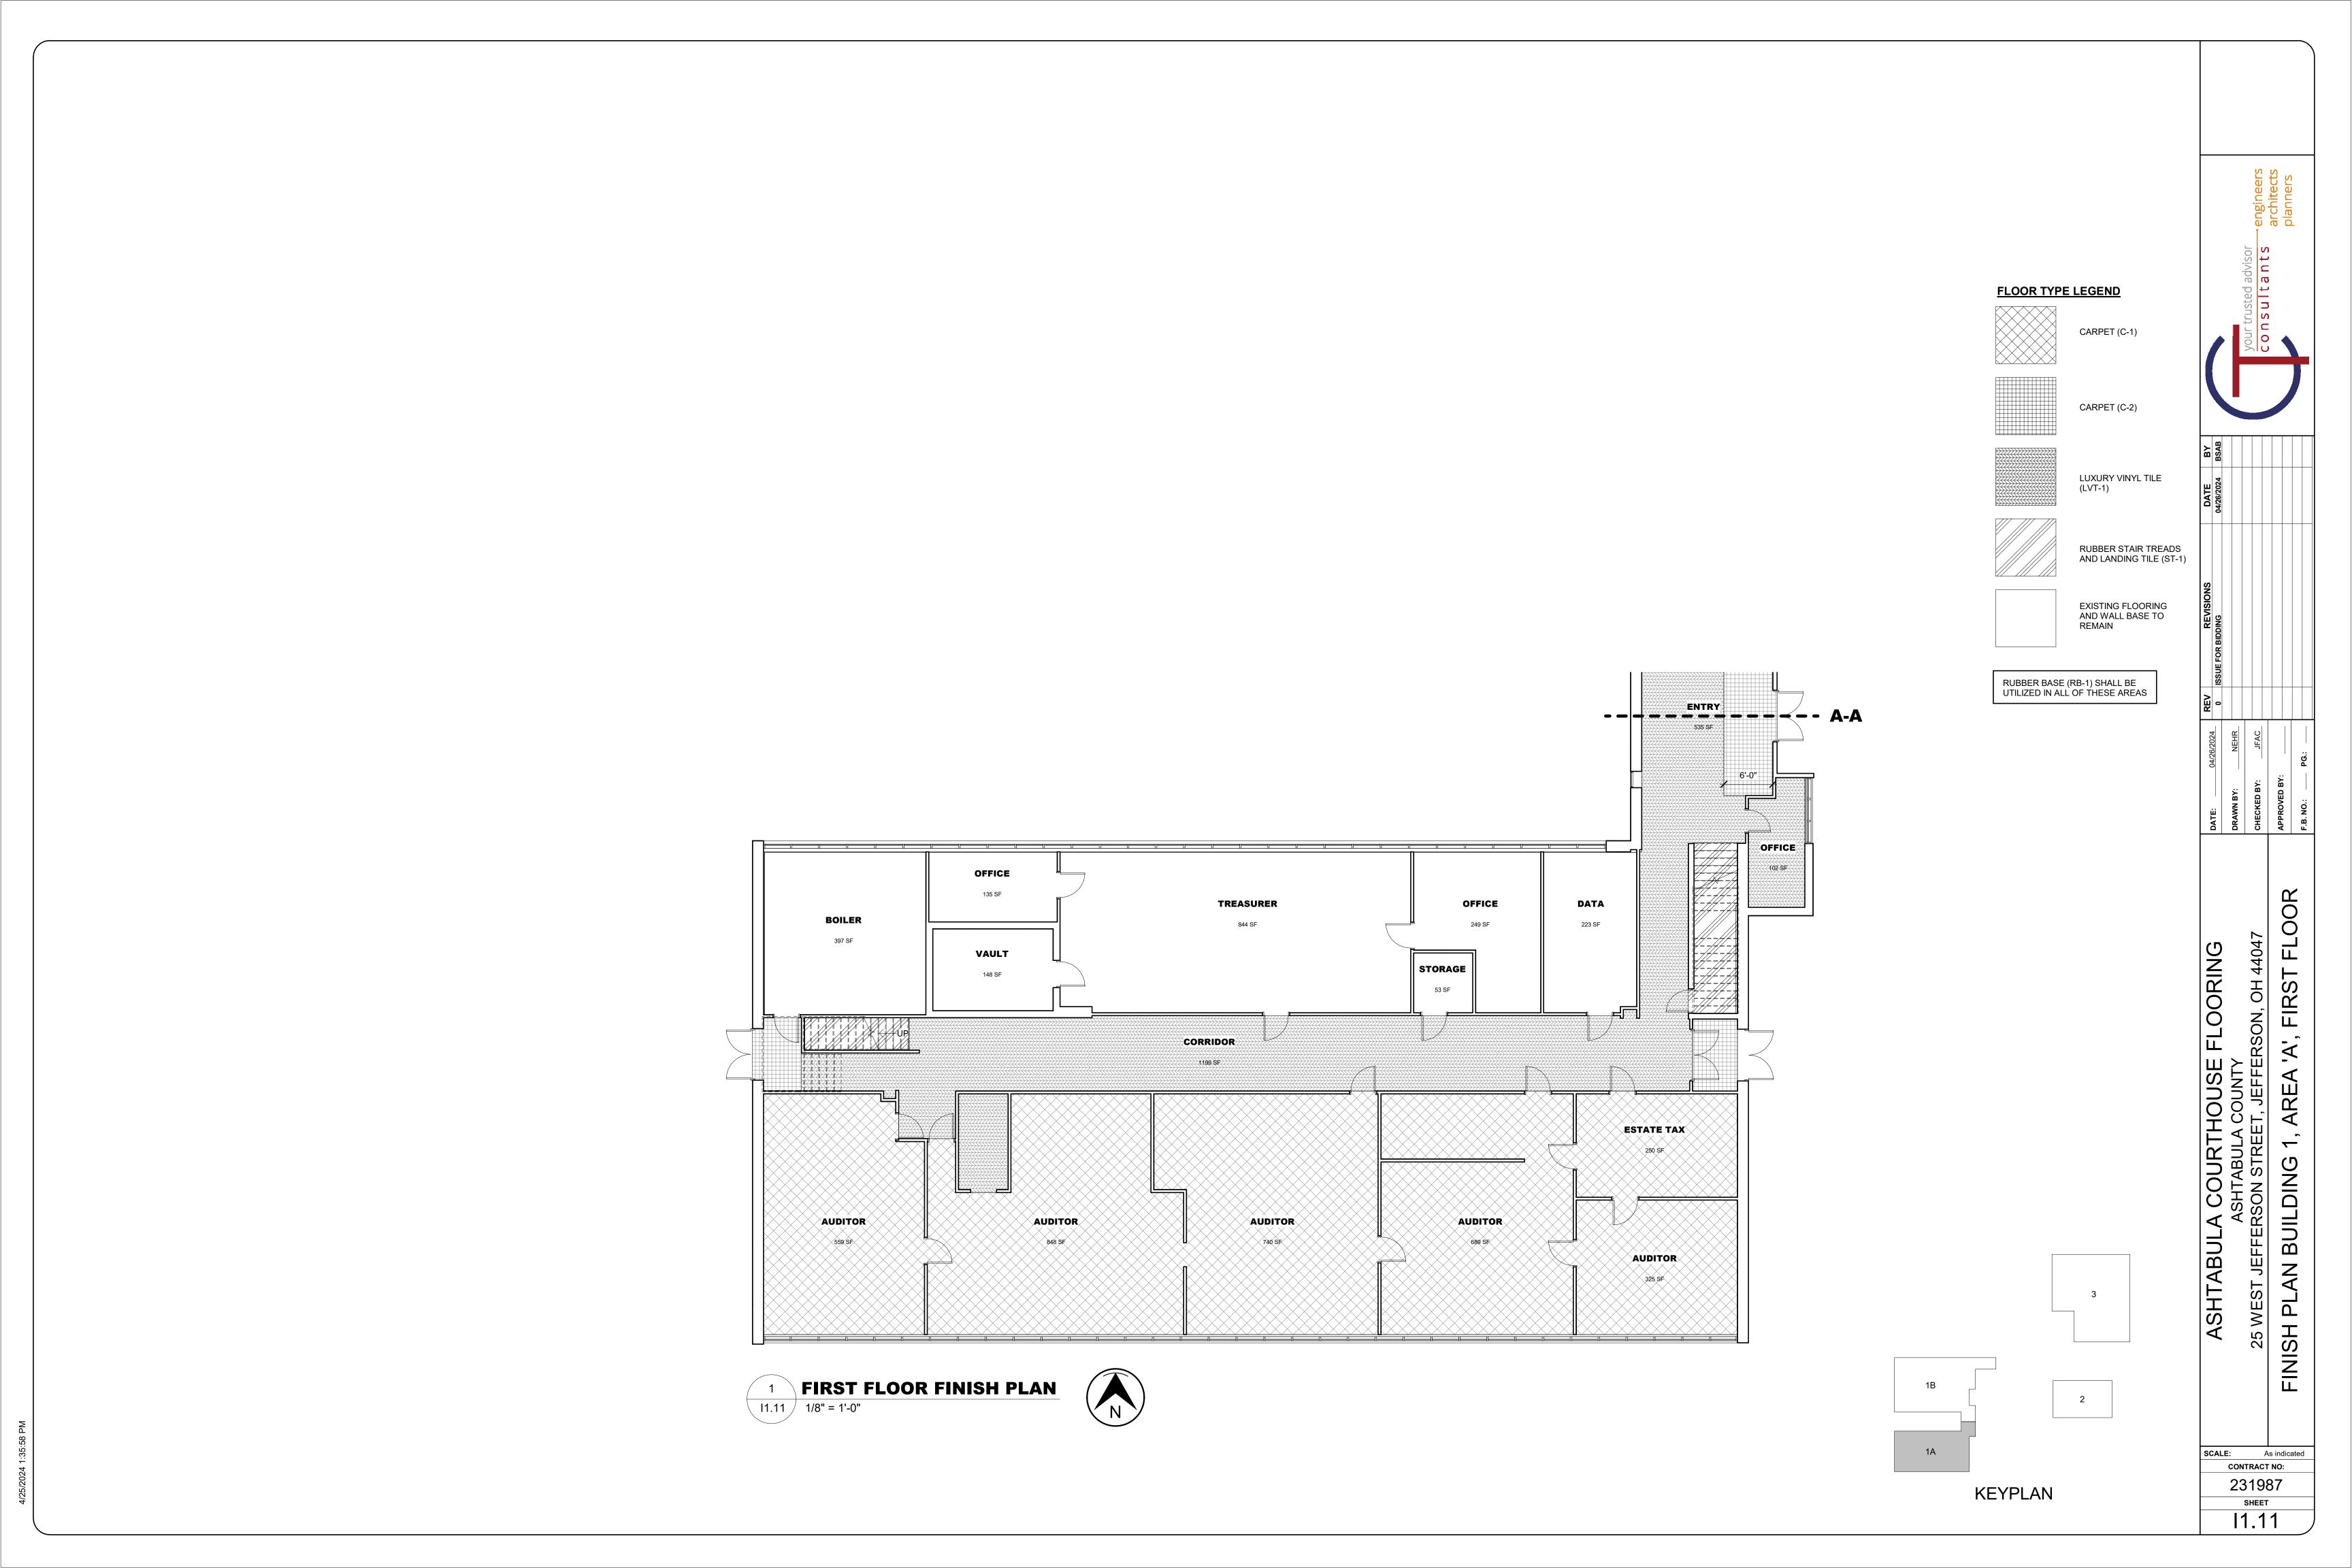
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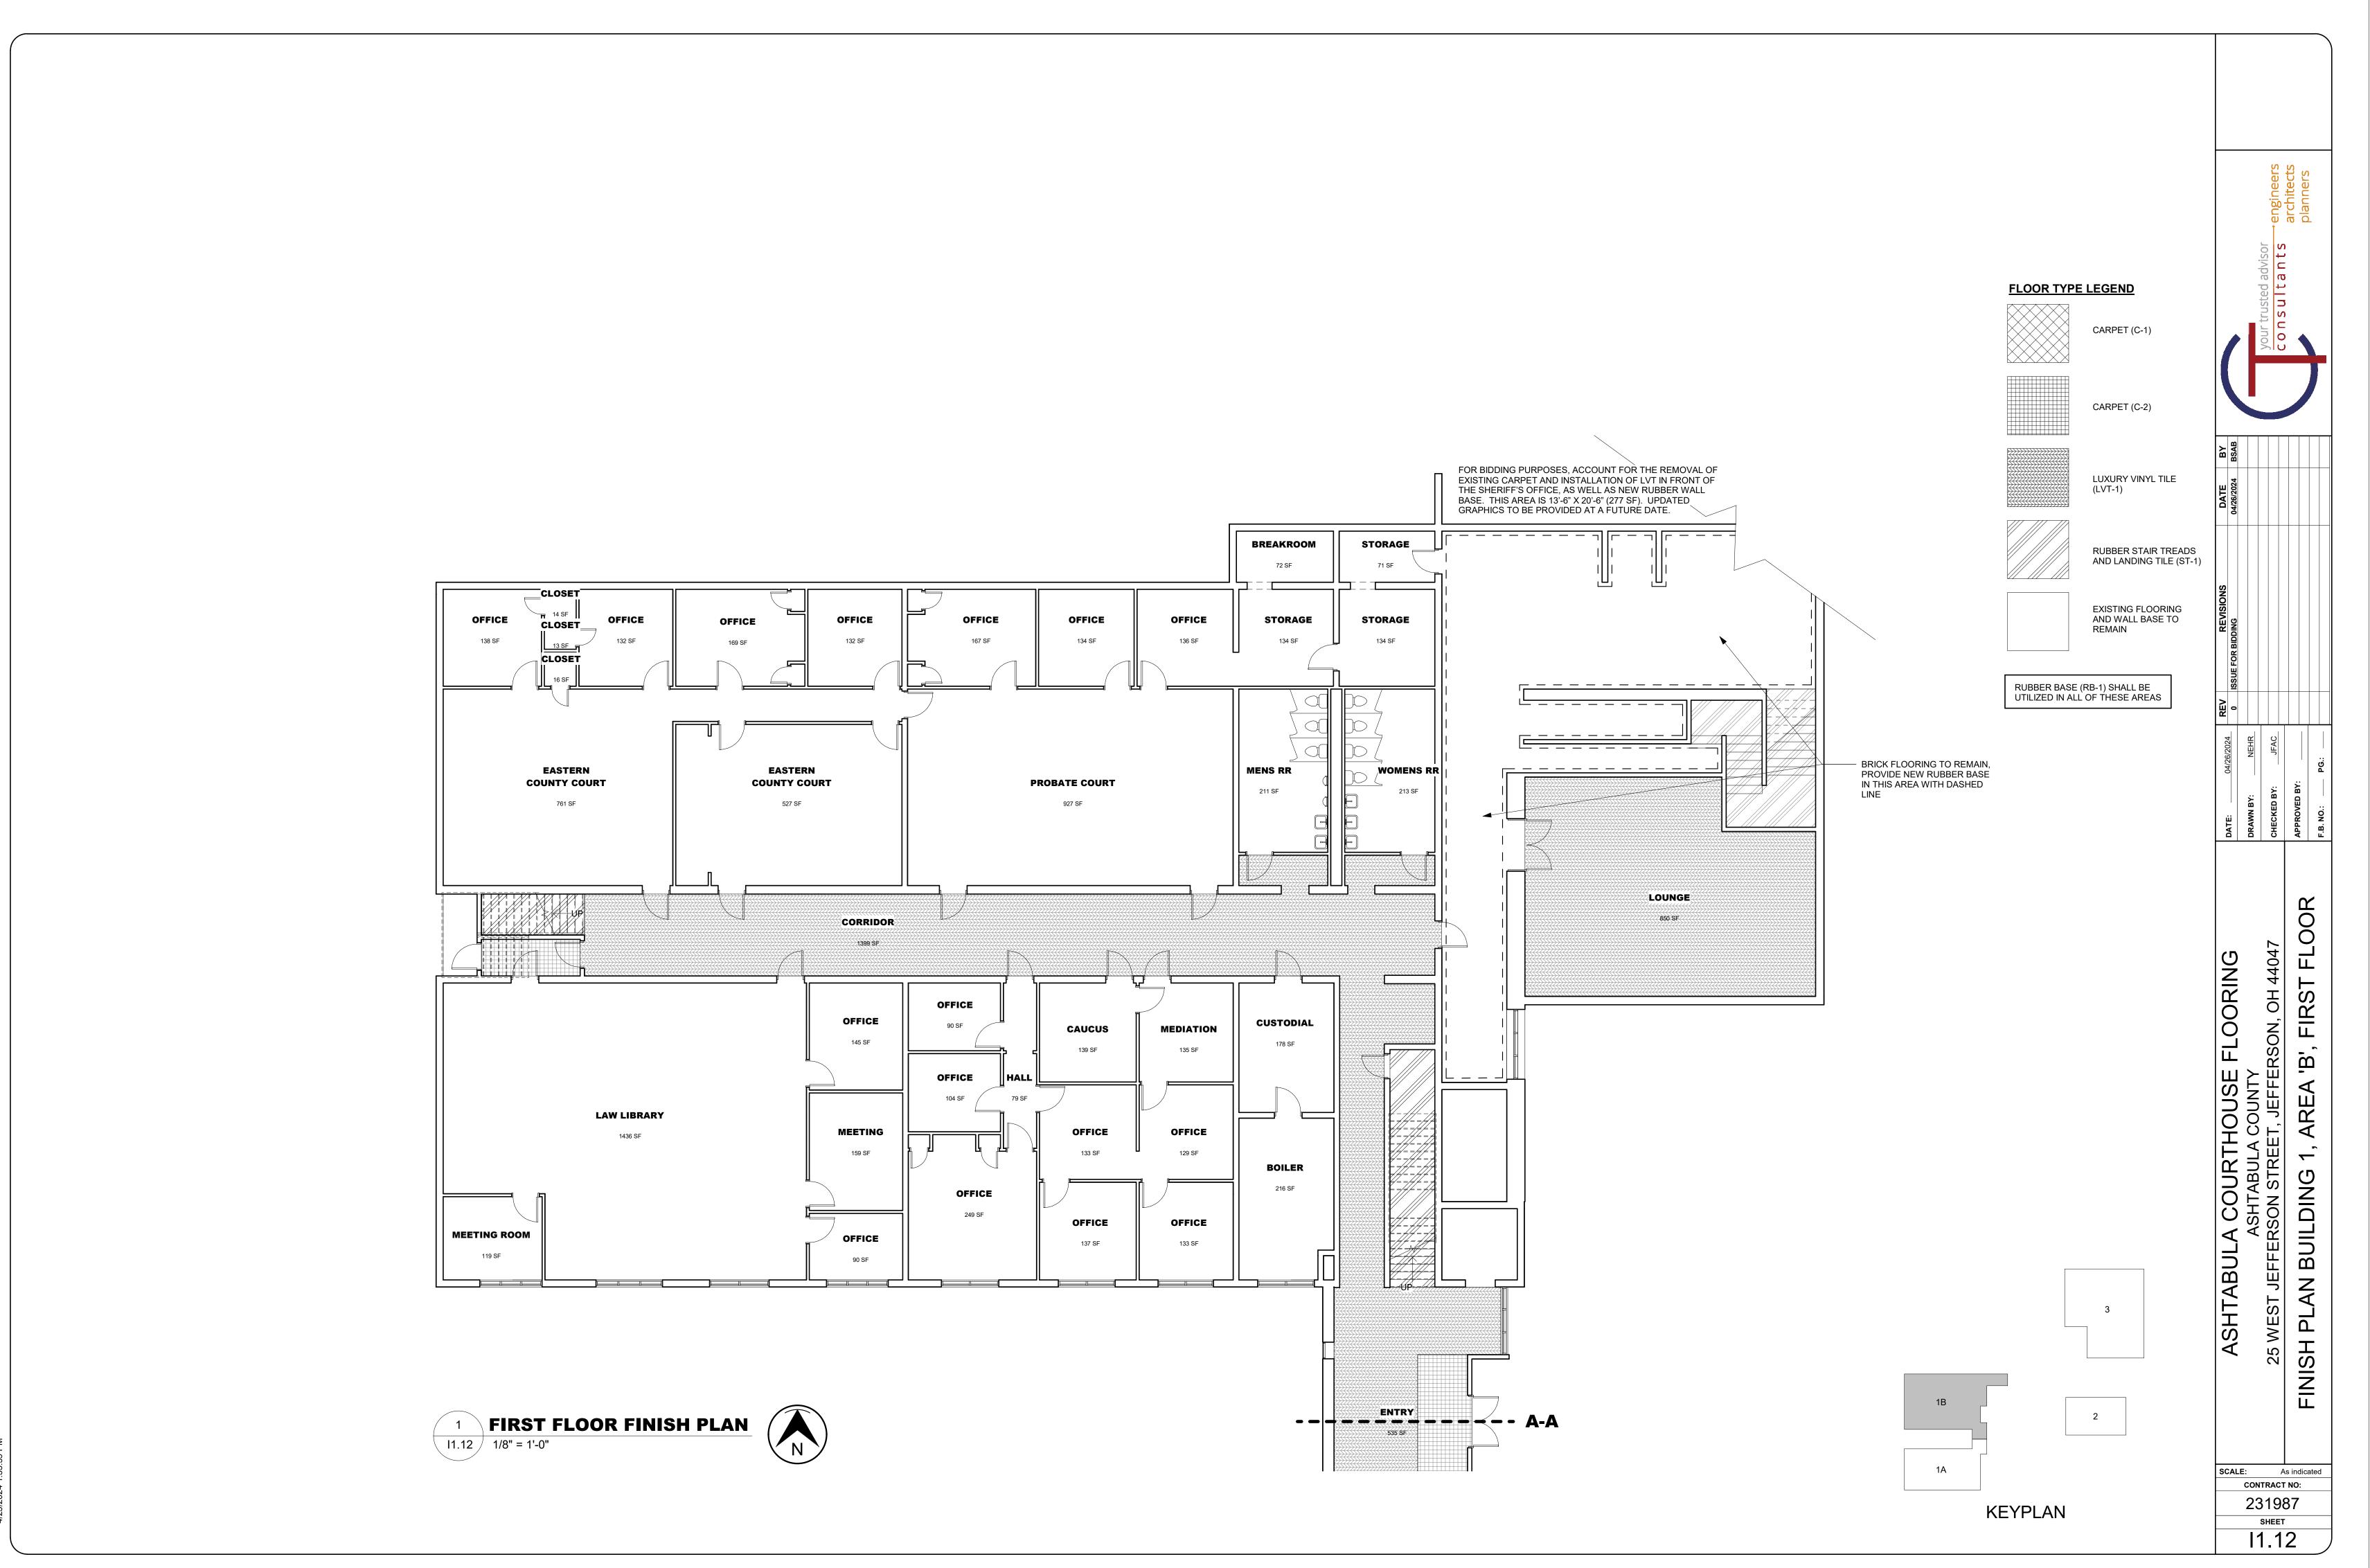
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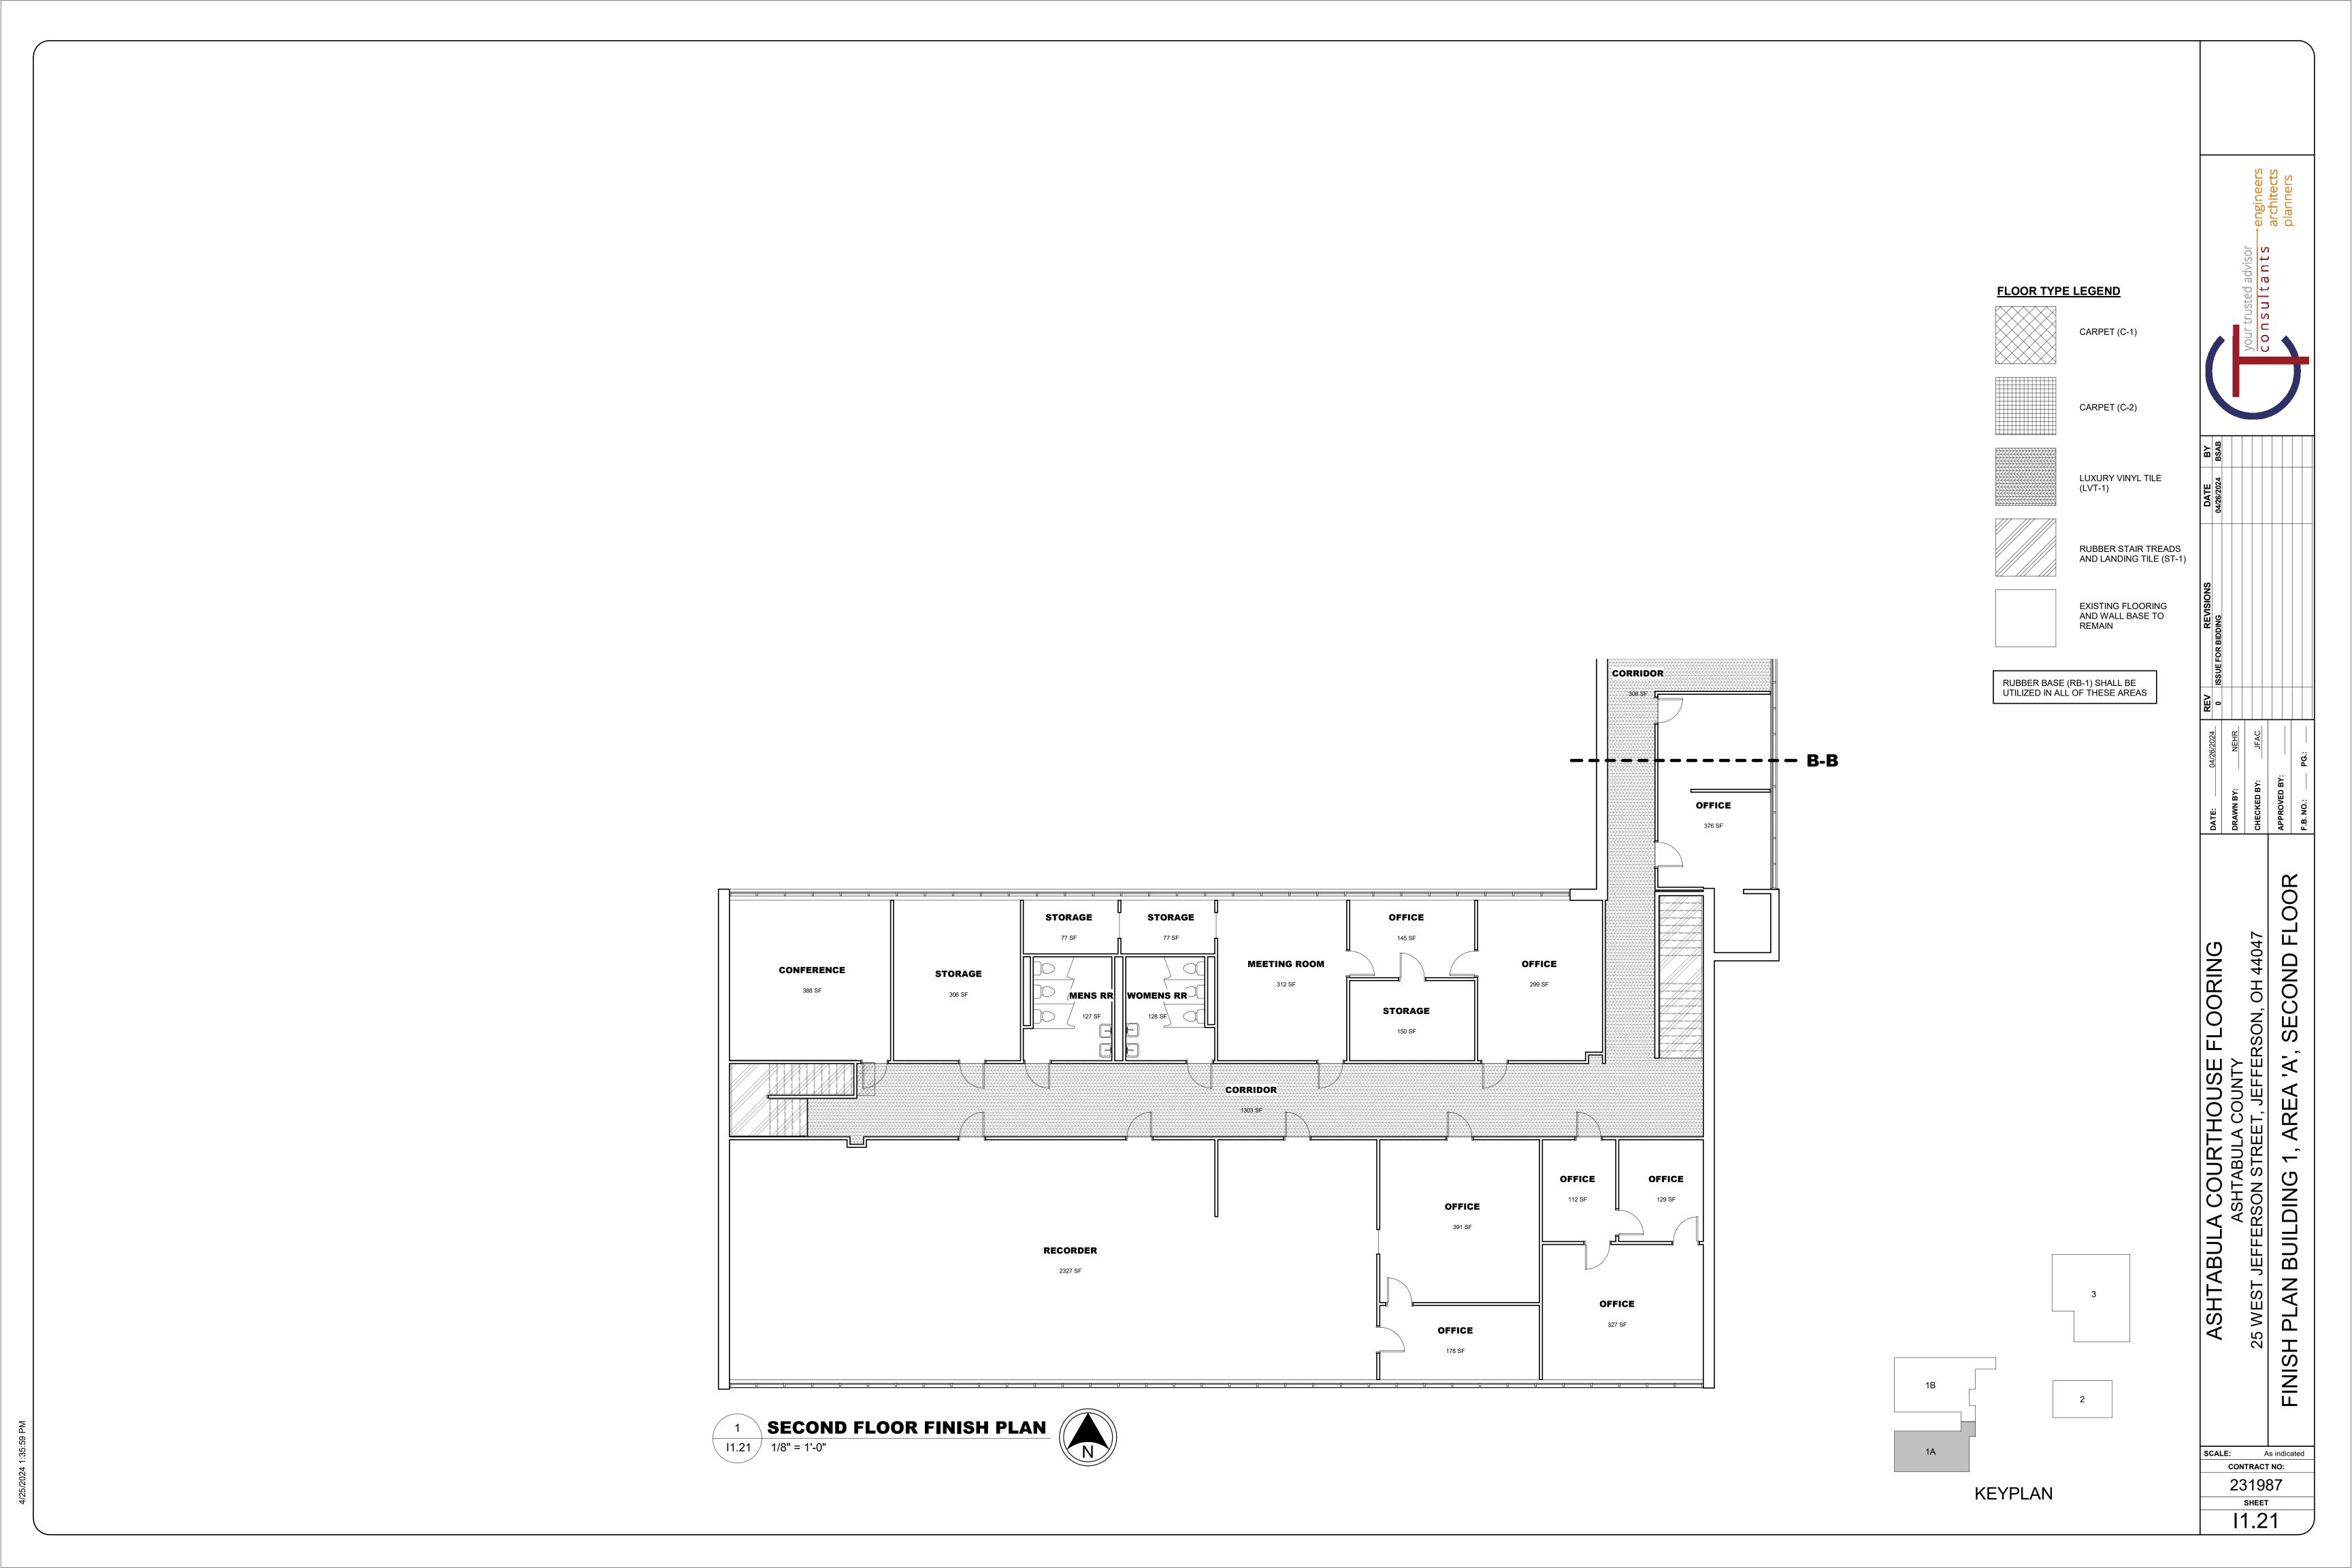
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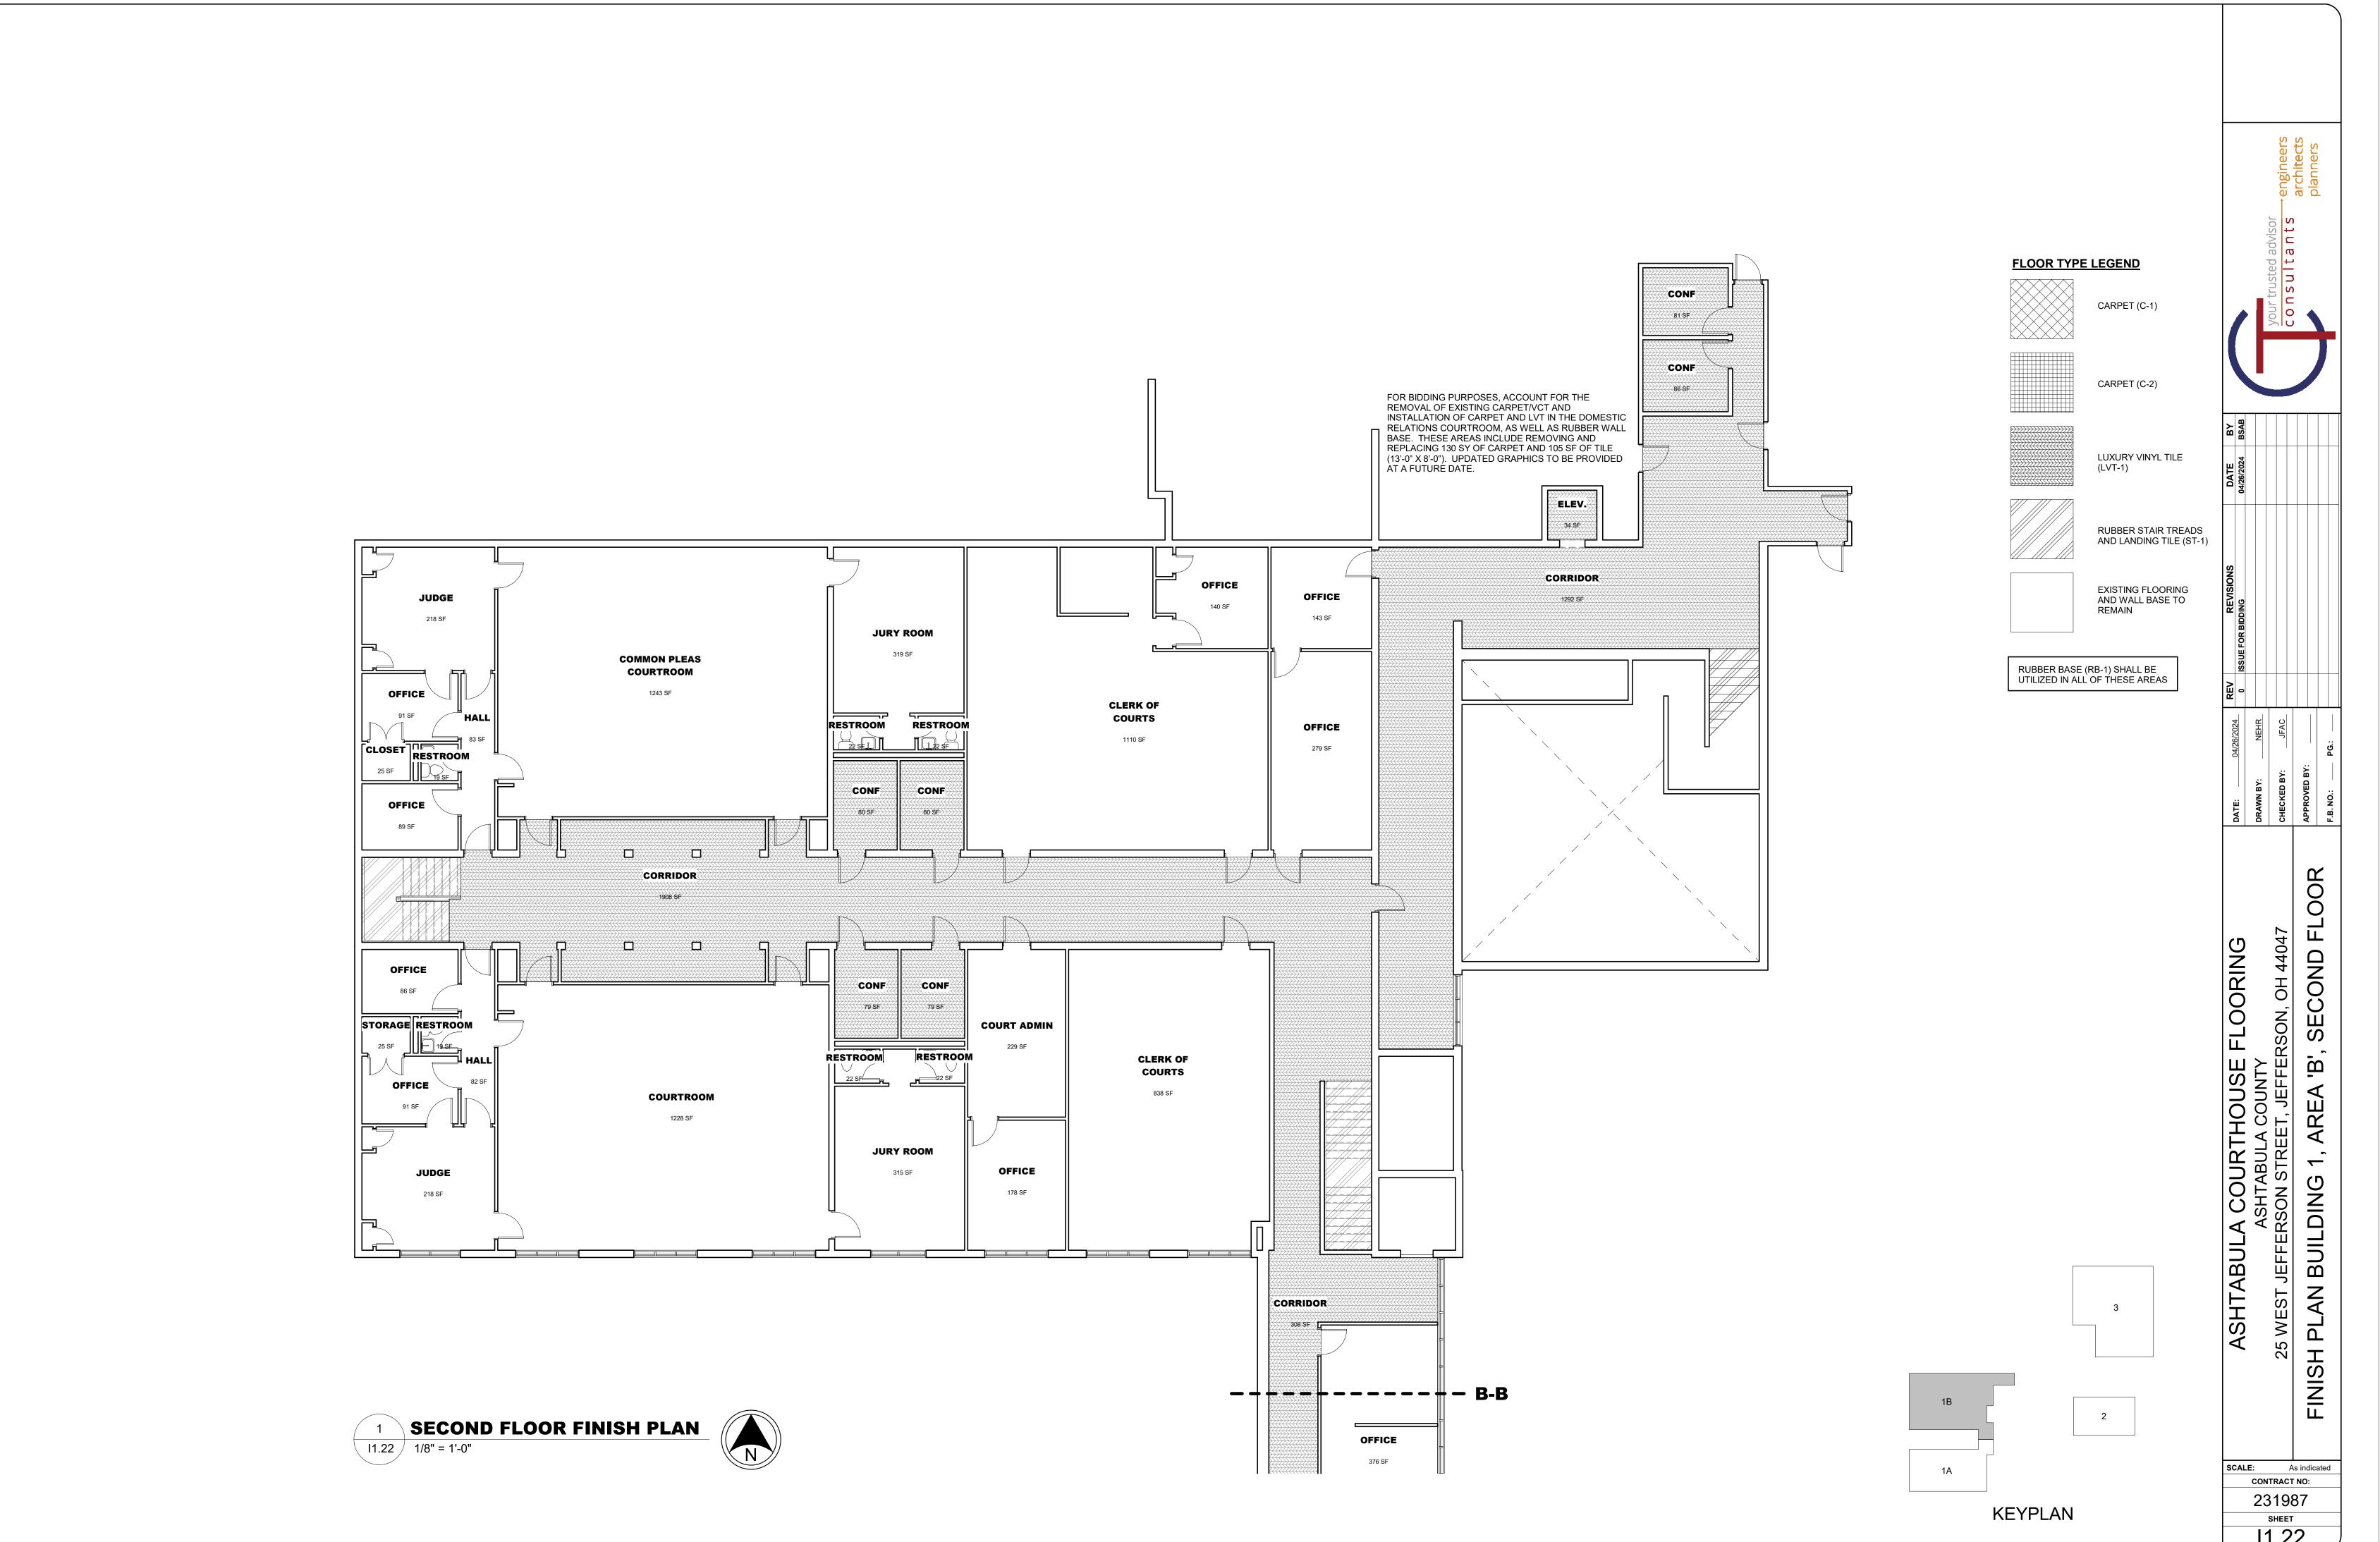
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